

THREE INCHES= ONE FOOT (3" = 1'-0")

ONE AND ONE HALF INCHES= ONE FOOT (1 1/2" = 1'-0")

ONE INCH= ONE FOOT (1" = 1'-0")

THREE QUARTERS INCH= ONE FOOT (3/4" = 1'-0")

ONE HALF INCH= ONE FOOT (1/2" = 1'-0")

THREE EIGHTHS INCH= ONE FOOT (3/8" = 1'-0")

ONE QUARTER INCH= ONE FOOT (1/4" = 1'-0")

ONE EIGHTH INCH= ONE FOOT (1/8" = 1'-0")

GENERAL ELECTRICAL NOTES


- G.1 PROVIDE LABOR, MATERIALS, TOOLS, EQUIPMENT, COORDINATION, DELEGATED DESIGN AND INCIDENTALS NECESSARY TO PROVIDE A COMPLETE AND OPERABLE SYSTEM.
- G.2 PERFORM WORK AS REQUIRED BY APPLICABLE CODES, REGULATIONS AND LAWS OF LOCAL, STATE AND FEDERAL GOVERNMENTS AND OTHER AUTHORITIES WITH LAWFUL JURISDICTION.
- G.3 MATERIAL AND EQUIPMENT SHALL BE LISTED AND LABELED BY NATIONALLY RECOGNIZED TESTING LABORATORIES FOR INTENDED SERVICE.
- G.4 GIVE NOTICES, FILE PLANS, OBTAIN PERMITS AND LICENSES, PAY FEES AND BACK CHARGES, AND OBTAIN NECESSARY APPROVALS FROM AUTHORITIES THAT HAVE JURISDICTION.
- G.5 MAINTAIN RECORD DRAWINGS ON SITE. RECORD SET SHALL BE COMPLETE, CURRENT, AND AVAILABLE UPON REQUEST.
- G.6 SUBMIT FOR APPROVAL, SHOP DRAWINGS FOR EQUIPMENT AND MATERIALS USED ON PROJECT. OBTAIN APPROVAL BY ENGINEER PRIOR TO PURCHASE OF EQUIPMENT AND MATERIALS.
- G.7 REPAIR OR REPLACE DAMAGE TO FACILITIES AND EQUIPMENT AT NO ADDITIONAL EXPENSE TO OWNER.
- G.8 PATCH AND REPAIR DISTURBED AREAS TO MATCH ADJACENT SURFACES AND FINISHES.
- G.9 PROVIDE TEMPORARY POWER AND LIGHTING FOR OTHER TRADES AS REQUIRED TO COMPLETE PROJECT IN ACCORDANCE WITH APPLICABLE CODES AND STANDARDS.
- G.10 DRAWINGS ARE DIAGRAMMATIC AND INDICATE GENERAL ARRANGEMENT OF SYSTEMS. PROVIDE COMPONENTS INDICATED ON RISER DIAGRAMS WHETHER OR NOT INDICATED ON PLANS, AND VICE VERSA.
- G.11 LOCATIONS SHOWN ON PLANS ARE APPROXIMATE AND REQUIRE COORDINATION WITH OTHER TRADES. ROUTING OF CONDUIT IS DIAGRAMMATIC IN NATURE AND NOT INTENDED TO SHOW REQUIRED OFFSETS AND DETAILS. OBTAIN DRAWINGS AND SPECIFICATIONS FROM OTHER TRADES AND COORDINATE WITH OTHER TRADES.
- G.12 COORDINATE ELECTRICAL INSTALLATION WITH FIELD CONDITIONS. LOCATIONS SHOWN ARE DIAGRAMMATIC AND MAY REQUIRE ADJUSTMENT IN FIELD.
- G.13 COORDINATE LOCATIONS OF ELECTRICAL DEVICES WITH ARCHITECTURAL ELEVATIONS PRIOR TO INSTALLATION.
- G.14 REFER TO MECHANICAL DRAWINGS FOR EXACT LOCATION OF MECHANICAL EQUIPMENT REQUIRING ELECTRICAL CONNECTIONS.
- G.15 REFER TO ARCHITECTURAL DRAWINGS FOR FIRE RATED WALLS REQUIRING SPECIAL CONSTRUCTION.
- G.16 PERMANENTLY LABEL NEW ELECTRICAL EQUIPMENT, INCLUDING BUT NOT LIMITED TO, DEVICE DESIGNATION AND SUPPLY CIRCUIT DESIGNATION.
- G.17 CORE DRILL CONCRETE WALLS AND FLOORS TO PROVIDE OPENINGS FOR CONDUIT INSTALLATION. MAXIMUM CORE DRILL SIZE SHALL BE 5-INCH DIAMETER. SPACE CORE DRILL LOCATIONS A MINIMUM OF 6" FROM EACH OTHER, MEASURED FROM CORE DRILL OPENINGS. PROPERLY SEAL OPENINGS ACCORDING TO LOCATION AND APPLICATION.
- G.18 PROVIDE EACH CIRCUIT WITH A DEDICATED NEUTRAL UNLESS NOTED OTHERWISE.
- G.19 CONDUIT HOMERUNS SHOWN ON DRAWINGS WITH MORE THAN 3 CURRENT CARRYING CONDUCTORS ARE SHOWN DIAGRAMMATICALLY. DO NOT INSTALL MORE THAN 3 CURRENT CARRYING CONDUCTORS IN A SINGLE RACEWAY UNLESS INSTALLED IN ACCORDANCE WITH THE NATIONAL ELECTRIC CODE.
- G.20 PROVIDE FIREPROOFING FOR ELECTRICAL PENETRATIONS.
- G.21 INSTALL ELECTRICAL WORK IN A NEAT AND WORKMANLIKE MANNER, RECTILINEAR TO BUILDING STRUCTURE. INSTALL RACEWAYS TIGHT TO STRUCTURAL CEILING AND AS HIGH AS POSSIBLE WITHIN CEILING SPACES TO MAINTAIN MAXIMUM AMOUNT OF CLEAR SPACE BELOW RACEWAY.
- G.22 INSTALL RACEWAYS CONCEALED IN BUILDING FINISHES FOR ALL EXTERIOR MOUNTED DEVICES. DO NOT ROUTE EXPOSED ON BUILDING EXTERIOR.
- G.23 INSTALL RACEWAYS CONCEALED IN WALLS, UNDER FLOORS, ABOVE CEILINGS, ETC., EXCEPT AS FOLLOWS:
A. WHERE SUSPENDED CEILINGS ARE NOT PROVIDED.
B. IN VERTICAL SHAFTS, ELECTRICAL CLOSETS, ETC., MECHANICAL AND ELECTRICAL EQUIPMENT SPACES WHERE CONCEALMENT IS NOT PRACTICAL.
C. AT SURFACE-MOUNT PANELBOARDS IN OTHERWISE FINISHED SPACES LIMITED TO VERTICAL RUNS ABOVE AND BELOW PANEL.
D. WHERE REQUIRED FOR EQUIPMENT CONNECTIONS.
E. WHERE SPECIFICALLY INDICATED ON DRAWINGS.
- G.24 OWNER-FURNISHED EQUIPMENT: VERIFY AND COORDINATE ELECTRICAL ROUGH-IN REQUIREMENTS FOR OWNER-FURNISHED EQUIPMENT WITH OWNER PRIOR TO PULLING CONDUCTORS AND MAKING FINAL CONNECTIONS. LACK OF COORDINATION SHALL NOT JUSTIFY CHANGE ORDERS.
- G.25 WHERE SUBMITTED EQUIPMENT REQUIRES REVISION TO OVERCURRENT PROTECTION, CONDUIT, AND WIRING, COORDINATE AND MAKE CHANGE TO PROVIDE A COMPLETE INSTALLATION IN ACCORDANCE WITH APPLICABLE CODES.
- G.26 PROVIDE LABOR AND MATERIALS FOR A COMPLETE LIGHTNING PROTECTION SYSTEM. SYSTEM SHALL MEET THE REQUIREMENTS OF LPI-176 STANDARD OF PRACTICE AND UL-96, UL-96A AND NFPA-780 AND SHALL RECEIVE THE UL MASTER LABEL FOR THE ENTIRE BUILDING.
- G.27 ALL OCCUPIED AREAS WILL REMAIN OPERATIONAL DURING CONSTRUCTION. ANY BUILDING OUTAGES SHALL BE COMPLETED ON WEEKENDS OR OFF HOURS.

GENERAL ELECTRICAL DEMOLITION/RENOVATION NOTES

- G0.1 THE FACILITY WILL REMAIN OCCUPIED DURING RENOVATIONS.
- G0.2 MINIMIZE OUTAGES. COORDINATE OUTAGES WITH OWNER.
- G0.3 PRIOR TO DEMOLITION, FIELD VERIFY CONDUITS, CONDUCTORS, AND CABLES THAT PASS THROUGH AND SERVE AREAS OUTSIDE THE SCOPE OF WORK. MAINTAIN CONTINUITY OF SYSTEMS. PROTECT OR RELOCATE SYSTEMS TO PREVENT DAMAGE. RESTORE SYSTEMS TO NORMAL OPERATION. COORDINATE SYSTEM OUTAGES WITH OWNER.
- G0.4 IDENTIFY NONFUNCTIONING EQUIPMENT AND DEVICES TO REMAIN AFTER DEMOLITION. NOTIFY OWNER IN WRITING PRIOR TO DEMOLITION. UPON COMPLETION OF WORK, ENSURE THAT EXISTING EQUIPMENT AND DEVICES OPERATE PROPERLY.
- G0.5 IN AREAS REQUIRING THE PERFORMANCE OF WORK OF OTHER TRADES, CAREFULLY DISCONNECT, MAKE SAFE, REMOVE AND STORE ELECTRICAL ITEMS IN PATH OF WORK. REINSTALL AND RECONNECT SAME AFTER COMPLETION OF OTHER TRADE'S WORK. COORDINATE REMOVAL OF EQUIPMENT WITH OTHER TRADES PRIOR TO DEMOLITION.
- G0.6 AFTER DEMOLITION VERIFY AND SUPPORT REMAINING CABLES, WIRES, AND CONDUIT IN ACCORDANCE WITH THE APPLICABLE VERSION OF THE NEC. DISCONNECT, MAKE SAFE AND REMOVE ABANDONED AND TEMPORARY WIRE WITHIN SPACE.
- G0.7 EXISTING CONDITIONS REFLECT GENERAL OBSERVATIONS AND ARE NOT INTENDED TO INDICATE DETAILS OR DIMENSIONS. NO ATTEMPT HAS BEEN MADE TO SHOW ALL ELECTRICAL EQUIPMENT. VERIFY EXISTING CONDITIONS PRIOR TO PERFORMING WORK. NOTIFY ARCHITECT IN WRITING IF CONDITIONS ARE DISCOVERED THAT PREVENT EXECUTION OF WORK.
- G0.8 PROTECT REMAINING ELECTRICAL SYSTEMS AND COMPONENTS FROM DAMAGE. REMOVE PROTECTIVE MATERIALS UPON COMPLETION OF WORK.
- G0.9 IN AREAS NOTED TO REMOVE ELECTRICAL WORK, REMOVE CONDUITS AND ASSOCIATED SUPPORTS BACK TO POINT OF CONCEALMENT AND REMOVE WIRING BACK TO REMAINING ACTIVE DEVICES OR SOURCE.
- G0.10 DISPOSE OF LIGHTING BALLASTS AND CAPACITORS CONTAINING PCB'S, AS DEFINED BY THE ENVIRONMENTAL PROTECTION AGENCY (EPA), IN ACCORDANCE WITH APPLICABLE LOCAL, STATE, FEDERAL AND EPA REGULATIONS.
- G0.11 PROVIDE OWNER WITH INVENTORY OF MAJOR ELECTRICAL ITEMS TO BE REMOVED. OWNER WILL SELECT ITEMS TO BE SALVAGED. TURN SALVAGED ITEMS OVER TO OWNER. ITEMS REJECTED BY THE OWNER SHALL BECOME THE PROPERTY OF THE CONTRACTOR. REMOVE DEMOLISHED ITEMS FROM SITE.
- G0.12 UPDATE PANELBOARD DIRECTORIES TO INCLUDE MODIFICATIONS BY THIS PROJECT. TRACE CIRCUITS TO IDENTIFY UNLABELED LOADS.
- G0.13 REPAIR DISTURBED AREAS TO MATCH EXISTING CONDITIONS.
- G0.14 PROVIDE BLANK COVER PLATES FOR DEVICES REMOVED WHEN A REPLACEMENT DEVICE IS NOT INDICATED.
- G0.15 MAINTAIN CONTINUITY OF CIRCUITS AND FEEDERS REMAINING AFTER DEMOLITION IN PANELS INDICATED TO BE DEMOLISHED OR REPLACED. EXTEND EXISTING CIRCUITS AND FEEDERS REMAINING AFTER DEMOLITION TO NEW PANELS. CIRCUIT BREAKER, CONDUIT, AND WIRE SHALL MATCH EXISTING TYPES AND SIZES.
- G0.16 WHERE CIRCUITS ARE REMOVED BACK TO PANELS, ASSOCIATED BREAKERS WILL BE UTILIZED FOR NEW CIRCUITING.

ELECTRICAL CONVENTIONS


LIGHTING

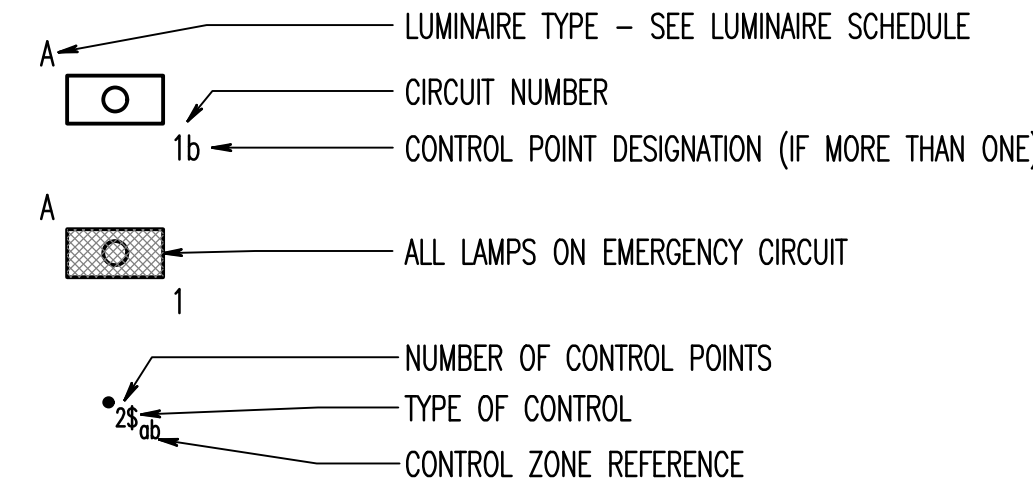

REFERENCE


- ① SPECIAL NOTE (APPLIES WHERE INDICATED ON THE DRAWING)
- D.1 DRAWING NOTE (APPLIES TO ENTIRE DRAWING)
- G.1 GENERAL NOTE (APPLIES TO ENTIRE DRAWING SET)

WIRING

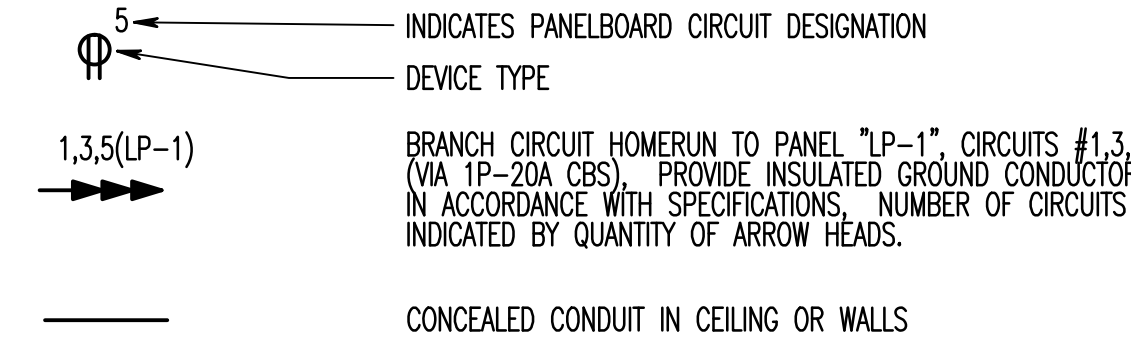


GENERAL NOTE: WHERE WIRE SIZE IS INDICATED AT THE HOMERUN OR ON THE SCHEDULE TO BE LARGER THAN THE SPECIFIED MINIMUM PROVIDE THE INDICATED WIRE SIZE THROUGHOUT THE ENTIRE BRANCH CIRCUIT.

MOUNTING HEIGHTS

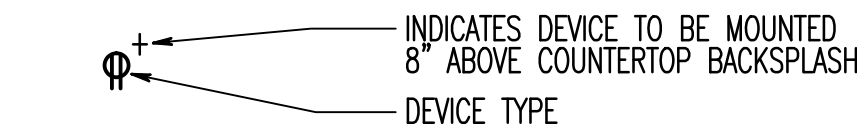

PRESENTATION

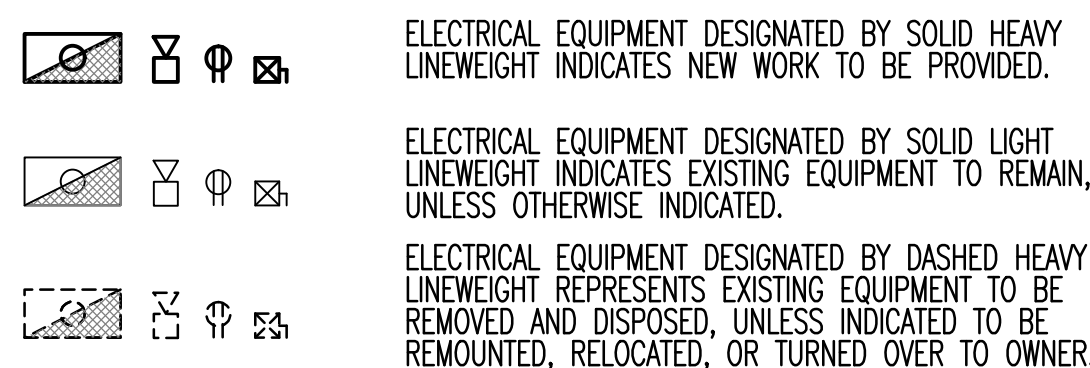

GENERAL ELECTRICAL COMMUNICATIONS NOTES

TELEPHONE AND DATA REQUIREMENTS:

- CABLE DESCRIPTION FOR STATION CABLES:
 - ALL CABLES SHALL BE UNSHIELDED TWISTED 4-PAIR, CAT-5E RATED.
 - DATA CABLE SHEATH SHALL BE "DARK BLUE" IN COLOR.
 - VOICE CABLE SHEATH SHALL BE "GRAY" IN COLOR.
 - ALL CABLES MUST BE ONE CONTINUOUS RUN BETWEEN WORK STATION AND COMMUNICATIONS CLOSET -- NO SPLICES.
- TERMINATING CABLE -- IN COMMUNICATION ROOM:
 - ALL DATA SHALL BE TERMINATED ONTO CAT-5E RATED PATCH PANELS RJ-45. DATA CABLES SHALL BE TERMINATED USING EIA/TIA-568A WIRING CONFIGURATION. DATA CABLES SHALL BE TERMINATED INTO PATCH PANELS MOUNTED ON A STANDARD 19-INCH DATA RACK.
 - ALL VOICE CABLES SHALL BE TERMINATED ONTO 110 WALL MOUNTED BLOCKS. CABLE NUMBERING WILL CONTINUE FROM THE EXISTING CABLES ALREADY IN PLACE.
 - CONTRACTOR SHALL PROVIDE PATCH PANELS AND 110 WALL MOUNTED BLOCKS AS REQUIRED FOR A COMPLETE INSTALLATION. COORDINATE WITH RESIDENT ENGINEER FOR ADDITIONAL REQUIREMENTS.
- TERMINATING CABLE -- AT WORK STATION:
 - ALL DATA CABLES SHALL BE TERMINATED ON CAT-5E RATED RJ-45 JACK INSERTS, USING EIA/TIA-568A WIRING CONFIGURATION.
 - ALL DATA JACK INSERTS SHALL BE BLACK IN COLOR.
 - ALL VOICE CABLES SHALL BE TERMINATED ONTO RJ-11 JACK INSERTS USING STANDARD USOC WIRING CONFIGURATION.
 - ALL VOICE JACK INSERTS SHALL BE OFFICE WHITE IN COLOR.
 - ALL JACK INSERTS SHALL BE INSTALLED ONTO FLUSH WALL MOUNTED FACE PLATES. FACE PLATES SHALL BE OFFICE WHITE IN COLOR. EACH FACE PLATE SHALL BE A 4-PORT CONFIGURATION.
 - WORK STATION SHALL BE WIRED WITH 2-DATA CABLES AND 1-VOICE CABLE.
- CABLE LABELING (NUMBERS ONLY)
 - ALL CABLES SHALL BE NUMBERED SEQUENTIALLY AND MECHANICALLY STENCILED WITH BLACK INK -- NOT HAND WRITTEN. CABLE NUMBER LABELS SHALL BE PLACED AT BOTH ENDS OF EACH CABLE, ON PATCH PANELS, AND WALL MOUNTED FACE PLATES.
 - IF CABLE NUMBERS ALREADY EXISTS IN COMMUNICATIONS ROOMS, NUMBER LABELING SEQUENCE SHALL BE A CONTINUATION OF EXISTING CABLE NUMBERS ALREADY IN PLACE ON DATA PATCH PANELS AND VOICE CABLES.
- CABLE MANAGEMENT
 - ALL CABLES SHALL BE HOME RUN FROM EACH WORKSTATION AREA TO THE DESIGNATED COMMUNICATIONS ROOM.
 - ALL CABLES IN AREAS WITH SUSPENDED CEILINGS SHALL BE SUSPENDED IN CEILING USING J-TYPE HOOKS.
 - ALL CABLES IN WAREHOUSE AREAS, OR OTHER AREAS WITHOUT CEILING SHALL BE ROUTED IN CONDUIT.
 - IN OFFICE AREAS ALL CABLES SHALL BE INSTALLED INSIDE WALLS AND NOT VISIBLE ON WALL SURFACES.
 - ALL WALL PENETRATIONS MADE ABOVE CEILINGS THROUGH FIRE RATED WALLS SHALL BE SEALED WITH FIRE RATED MATERIALS. IF EXISTING CONDUITS ARE USED AND FIRE STOPPER MATERIAL IS REMOVED FROM CONDUITS, CONDUITS SHALL BE RESEALED WITH RATED MATERIALS ONCE CABLES ARE INSTALLED.
 - CABLES IN COMMUNICATION ROOMS SHALL BE NEATLY RUN INTO RACK COMPATIBLE CABLE MANAGEMENT SYSTEMS RACEWAYS.
- SELECTION OF MATERIAL: ALL MATERIALS SELECTED FOR USE BY INSTALLATION CONTRACTOR MUST BE APPROVED BY VA TELECOMMUNICATIONS PERSONNEL PRIOR TO INSTALLATION.
- TESTING CABLE: ALL CABLES INSTALLED MUST BE TESTED AND VERIFIED FOR FULL 100MB TRANSMISSION SPEED AND CONTINUITY TO VERIFY THAT ALL PAIRS ARE FUNCTIONAL TO SUPPORT VOICE AND DATA SYSTEMS. TEST RESULTS MUST BE PRINTED AND PROVIDED TO VA TELECOMMUNICATIONS PERSONNEL PRIOR TO ACCEPTANCE OF THE WORK THAT WAS PERFORMED.
- REUSE OF EXISTING CABLE (FOR USE WITH PRE-EXISTING STRUCTURES ONLY)
 - IF EXISTING CABLE APPEAR TO BE FEASIBLE, PRIOR TO DISCONNECTING OR REMOVING CABLE IN CONSTRUCTION AREA, IDENTIFY CABLE NUMBER ASSOCIATED WITH EACH CABLE. THE ORIGINAL CABLE NUMBERS MUST BE STENCIL ON THE NEW FACE PLATE AT THE NEW WORK STATION JACK.
 - AFTER TERMINATION, ALL REUSED CABLES MUST BE TESTED TO CONFORM WITH CONTINUITY TESTING AND 100 MEGB TRANSMISSION SPEEDS.
- QUALIFICATIONS: ALL CABLE INSTALLATION AND TERMINATIONS MUST BE INSTALLED BY TRAINED AND CERTIFIED PERSONNEL MEETING CERTIFICATION STANDARDS, I.E., EIA, TIA, ANSI, BICSI, TDM, ITU-R, NFPA, NEC AND NCS.

ELECTRICAL ABBREVIATIONS

A	AMPERE	MCB	MAIN CIRCUIT BREAKER
ACH	ABOVE CABINET HEIGHT	MCC	MOTOR CONTROL CENTER
ACU	AIR CONDITIONING UNIT	MCP	MOTOR CIRCUIT PROTECTOR
AFF	ABOVE FINISHED FLOOR	MDP	MAIN DISTRIBUTION PANEL
AFG	ABOVE FINISHED GRADE	MH	MANHOLE
AHU	AIR HANDLING UNIT	M/L	MAIN LUGS
AIC	AMPERE INTERRUPTING CAPACITY	M/OA	MULTI OUTLET ASSEMBLY
ASYM	ASYMMETRICAL	MSP	MOTOR STARTER PANEL
ATS	AUTOMATIC TRANSFER SWITCH	MTD	MOUNTED
		MV	MEDIUM VOLTAGE
C	CONDUIT		NORMALLY CLOSED
CB	CIRCUIT BREAKER	NC	NURSE CALL EQUIP. CABINET
CCTV	CLOSED CIRCUIT TELEVISION	NCEC	NON-FUSED
CKT	CIRCUIT	NF	NORMALLY OPEN
CT	CURRENT TRANSFORMER	NTS	NOT TO SCALE
CX	CONNECT TO EXISTING		
DP	DISTRIBUTION PANEL	OCP	OVERCURRENT PROTECTION
DT	DOUBLE THROW	OH	OVERHEAD
DWC	DRINKING WATER COOLER		
DWG	DRAWING	P	POLE(1P., 2P., 3P.)
E	EMERGENCY	PB	PUSH BUTTON
EBH	ELECTRIC BASEBOARD HEATER	PH	PHASE
EQUIP	EQUIPMENT	PL	PILOT LIGHT
ETR	EXISTING TO REMAIN	PP	POWER PANEL
EW	ELECTRIC WATER HEATER	PT	POTENTIAL TRANSFORMER
EXH	EXISTING	PVC	POLYVINYL CHLORIDE
F	FUSED OR FUSIBLE	R	RACEWAY
FA	FIRE ALARM	RCS	REMOTE CONTROL SWITCH
FCP	FIRE ALARM CONTROL PANEL	RP	RECEPTACLE PANEL
FCU	FAN COIL UNIT	RX	REMOVE EXISTING
FDR	FEEDER		
GFI	GROUND FAULT INTERRUPTER	SN	SOLID NEUTRAL
GW	GROUND WIRE	SS	SAFETY SWITCH
		ST	SINGLE-THROW
		SW	SWITCH
		SWBD	SWITCHBOARD
		SWGR	SWITCHGEAR
		SYM	SYMMETRICAL
HOA	HAND-OFF-AUTOMATIC	TS	TIE SWITCH
HP	HORSE POWER	TB	TELEPHONE TERMINAL BOARD
HPU	HEAT PUMP UNIT	TYP	TYPICAL
HV	HIGH VOLTAGE		
HZ	HERTZ	UG	UNDERGROUND
ICEC	INTERCOM EQUIPMENT CABINET	UH	UNIT HEATER
IG	ISOLATED GROUND	UON	UNLESS OTHERWISE NOTED
JB	JUNCTION BOX		
KCML	THOUSAND CIRCULAR MILS	V	VOLTS
KV	KILO-VOLTS	W	WIRE
KVA	KILO-VOLT-AMPERE	WP	WEATHER PROOF
KW	KILOWATTS	XFMR	TRANSFORMER
LAD	LOCATE AS DIRECTED		
LC	LOAD CENTER		
LP	LIGHTING PANEL		
LV	LOW VOLTAGE		

ELECTRICAL LEGEND

SYMBOL	DESCRIPTION	MOUNTING HEIGHT
	LUMINAIRE -- SEE SCHEDULE FOR TYPE (NOMINAL 2X2)	--
	LUMINAIRE -- SEE SCHEDULE FOR TYPE (NOMINAL 2X4)	--
	LUMINAIRE -- SEE SCHEDULE FOR TYPE (NOMINAL 1X4)	--
	LUMINAIRE -- SEE SCHEDULE FOR TYPE (STRIP)	--
	ILLUMINATED EXIT SIGN, SINGLE FACE -- SEE SCHEDULE FOR TYPE (ARROW INDICATED DIRECTIONAL CHEVRON) (CEILING AND WALL MOUNTED)	-- / 90"
	ILLUMINATED EXIT SIGN, DOUBLE FACE -- SEE SCHEDULE FOR TYPE (CEILING AND WALL MOUNTED)	-- / 90"
	SINGLE POLE TOGGLE SWITCH	46"
	THREE-WAY TOGGLE SWITCH	46"
	LIGHTING CONTROL SYSTEM -- LOW VOLTAGE SWITCH FOR ONE ZONE, ON/OFF CONTROL	46"
	LIGHTING CONTROL SYSTEM -- LOW VOLTAGE SWITCH FOR ONE ZONE, ON/OFF AND UP/DOWN DIMMING	46"
	OCCUPANCY SENSOR WALL SWITCH, PIR	46"
	OCCUPANCY SENSOR WALL SWITCH, MULTI-TECHNOLOGY, DUAL WITH ADAPTABILITY	46"
	OCCUPANCY SENSOR -- MULTI TECHNOLOGY, CEILING MOUNTED, 500 SQ FT RANGE	--
	OCCUPANCY SENSOR -- MULTI TECHNOLOGY, CEILING MOUNTED, 1000 SQ FT RANGE	--
	OCCUPANCY SENSOR -- MULTI TECHNOLOGY, CEILING MOUNTED, 2000 SQ FT RANGE	--
	OCCUPANCY SENSOR -- PIR, CEILING MOUNTED, HIGH BAY, 360 DEGREE OR ASLE LENS	--
	OCCUPANCY SENSOR -- PIR, CEILING MOUNTED, 450 SQ FT RANGE	--
	OCCUPANCY SENSOR -- PIR, CEILING MOUNTED, 1500 SQ FT RANGE	--
	OCCUPANCY SENSOR -- ULTRASONIC, CEILING MOUNTED, 1500 SQ FT RANGE	--
	OCCUPANCY SENSOR -- MULTI TECHNOLOGY, WALL MOUNTED, WIDE VIEW	92"
	PHOTOSENSOR (WALL AND CEILING MOUNTED)	--
	RECEPTACLE -- NEMA CONFIGURATION 5-20R DUPLEX	18"
	RECEPTACLE -- NEMA CONFIGURATION 5-20R QUAD	18"
	RECEPTACLE -- NEMA 5-20R DUPLEX WITH 5mA GROUND FAULT INTERRUPTER	18"
	RECEPTACLE -- TYPE AS INDICATED ON DRAWING	18"
	FRACTIONAL HORSEPOWER MANUAL MOTOR SWITCH	46"
	MOTOR	--
	SAFETY SWITCH	60" TO TOP
	JUNCTION BOX IN CEILING	--
	JUNCTION BOX -- WALL MOUNTED	AS NOTED
	PANELBOARD	78" TO TOP
	DRY TYPE TRANSFORMER -- SIZE AS INDICATED (PAD MOUNTED SEE DETAIL)	--
	VARIABLE FREQUENCY DRIVE	--
	COMBINATION TELEPHONE/DATA OUTLET, WALL MOUNTED	18"
	TELEPHONE OUTLET, WALL MOUNTED, WITH PULL TELEPHONE MOUNTING LUGS	52"
	SECURITY SYSTEM -- SURVEILLANCE CAMERA, PAN -- TILT -- ZOOM PROVIDE 1 DATA CONNECTION AT THIS LOCATION. CAMERA BY OTHERS	AS NOTED


NOTES: (APPLICABLE TO ELECTRICAL LEGEND ONLY)

- THE MOUNTING HEIGHTS GIVEN ON THIS SHEET IN THE ELECTRICAL LEGEND ARE GENERAL AND SHALL BE USED ONLY WHEN MOUNTING HEIGHTS CANNOT BE ESTABLISHED BY REFERENCE TO DETAILS, ELEVATIONS, AND NOTES ON THE DRAWINGS.
- ALL MOUNTING HEIGHTS, UNLESS OTHERWISE NOTED, SHALL BE MEASURED FROM THE FINISHED FLOOR TO THE CENTERLINE OF THE OUTLET OR DEVICE.
- HEIGHTS OF ALL ITEMS NOT COVERED BY THE ELECTRICAL LEGEND AND NOT SHOWN ON THE DRAWINGS SHALL BE AS DIRECTED BY THE ARCHITECT OR ENGINEER.
- WHERE PLACING ANY ITEM AT THE HEIGHTS LISTED OR NOTED WILL CAUSE INTERFERENCE WITH THE WORK OF OTHER TRADES, OR IS NOT PHYSICALLY POSSIBLE OR DESIRABLE FOR ONE REASON OR ANOTHER, THE ITEM SHALL BE INSTALLED AT A LOCATION APPROVED BY THE ARCHITECT OR ENGINEER.

FULLY SPRINKLERED

Additions:	Date
Revisions:	Date
SCHEMATIC DESIGN (30%) SUBMISSION	03/25/15
DESIGN DEVELOPMENT (60%) SUBMISSION	09/11/15
CONSTRUCTION DOCUMENTS (90% SUBMISSION)	11/23/15
BID DOCUMENTS	03/17/16

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Professional Certification: I hereby certify that these documents were prepared or approved by me, and that I am a duly licensed professional engineer under the laws of the State of Maryland.
License No.: 41408 ... Expiration Date: 11/30/18

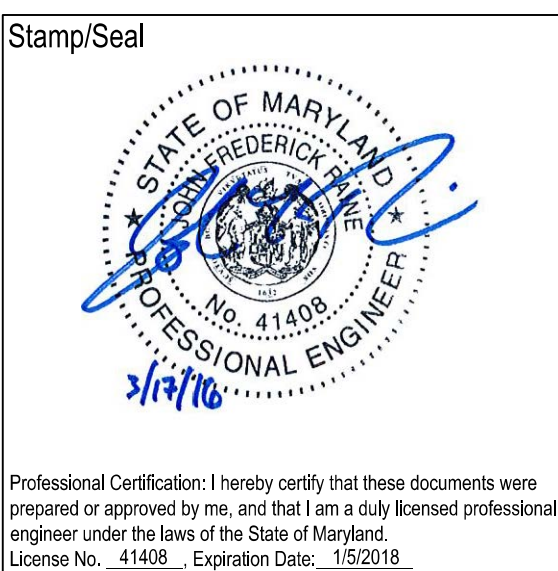Approved:	

Approved: Chief, Facilities and Engineering	
Approved: Associate Chief for Maintenance And Operations, Perry Point	
Approved: Engineering Projects Supervisor	
Approved: Infection Control Officer	

Drawing Title	ELECTRICAL COVER SHEET
Approved: Associate Director for Operations	
Approved: Director, Medical Center	

Project Title	WAREHOUSE RENOVATION & EXPANSION
Scale	NONE
Building Number	360
Checked	JFR
Drawn	MLS
Location	PERRY POINT, MD

Date	03/17/16
VA Project Number	512-530
Drawing Number	E001




DRAWING NOTES: (APPLICABLE TO THIS SHEET ONLY)

D1. EXISTING SHOWN WITH LIGHT WEIGHT LINE, _____
D2. NEW WORK SHOWN WITH HEAVY WEIGHT LINE, _____

SPECIAL NOTES: (APPLICABLE TO THIS SHEET ONLY)

- EXISTING SECONDARY ELECTRICAL SERVICE FROM TRANSFORMER TO SWITCHBOARD ON SECOND FLOOR TO REMAIN. SERVICE IS ROUTED IN DUCT BANK TO BUILDING, UP SIDE OF BUILDING TO SECOND FLOOR.
- ROLL UP GENERATOR CONNECTION CABINET. REFER TO RISER.
- GROUND RING. REFER TO GROUNDING RISER DIAGRAM FOR CONDUCTOR SIZE AND BURIAL DEPTH.

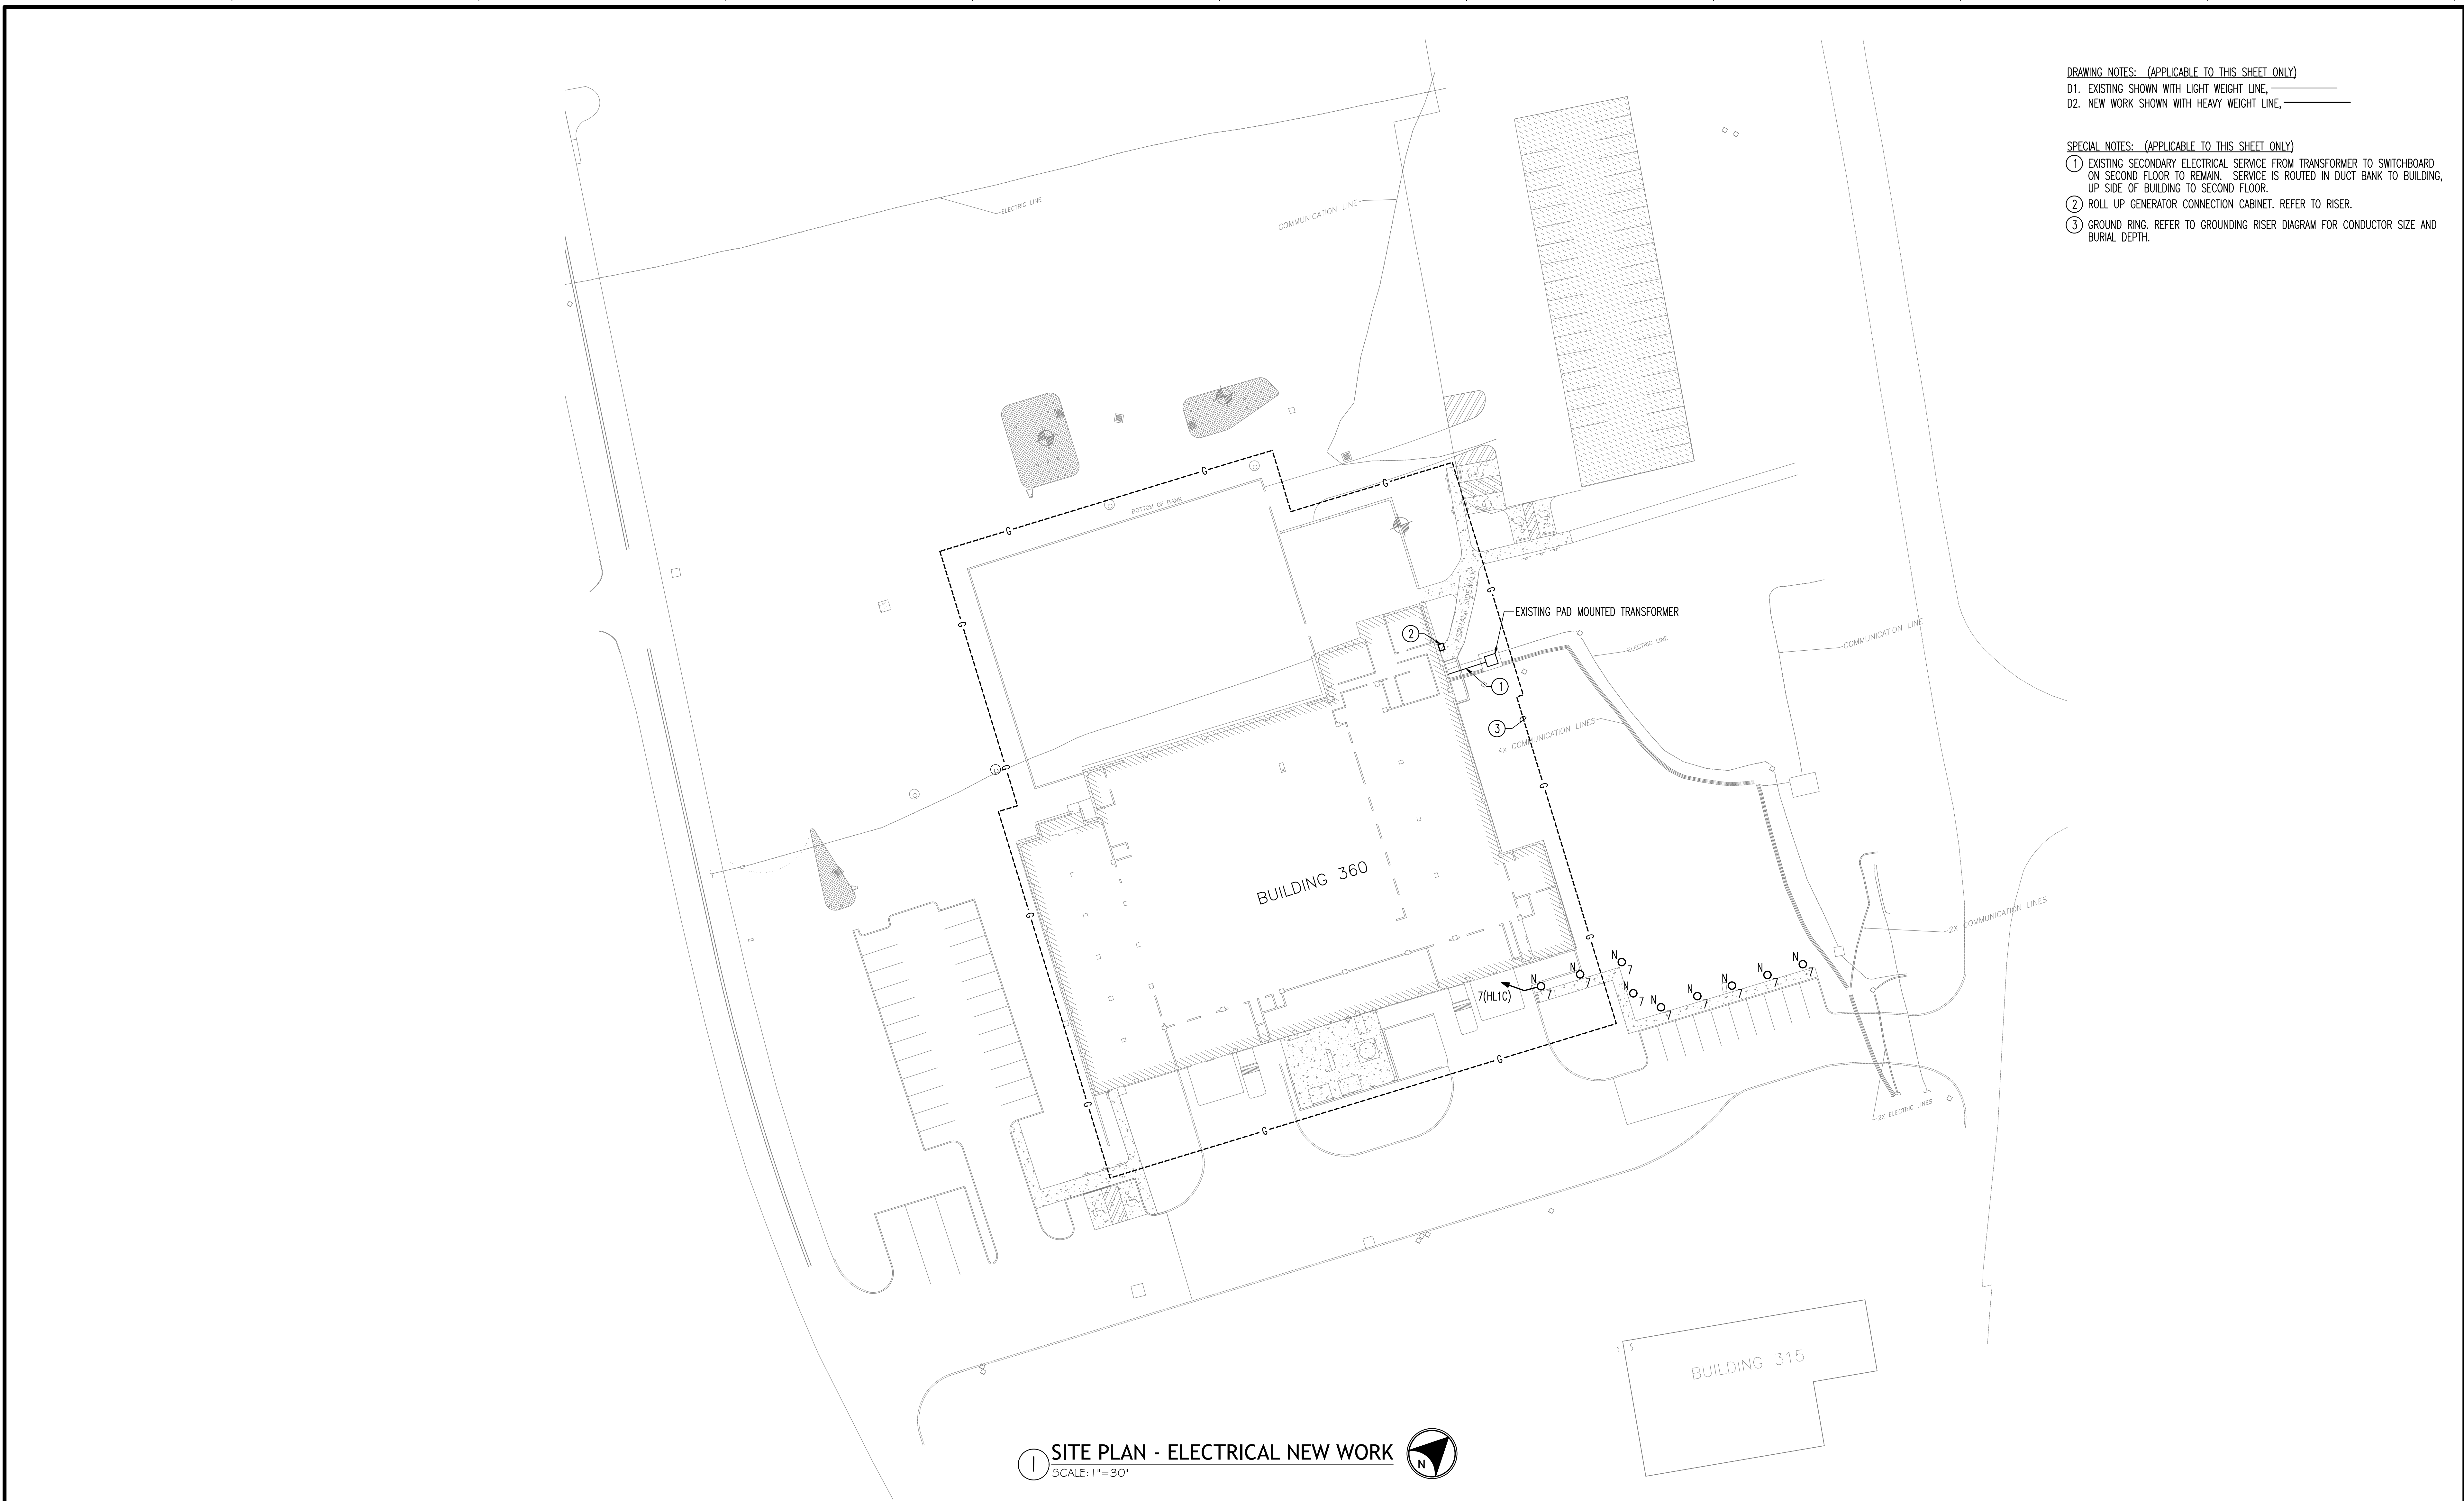


1 SITE PLAN - ELECTRICAL NEW WORK

SCALE: 1"=30'



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The Protection Engineering Group 2809 Boston Street, Suite 7 Baltimore, MD 21224 USA Tel: (443) 708-4096 Fax: (443) 708-4096			

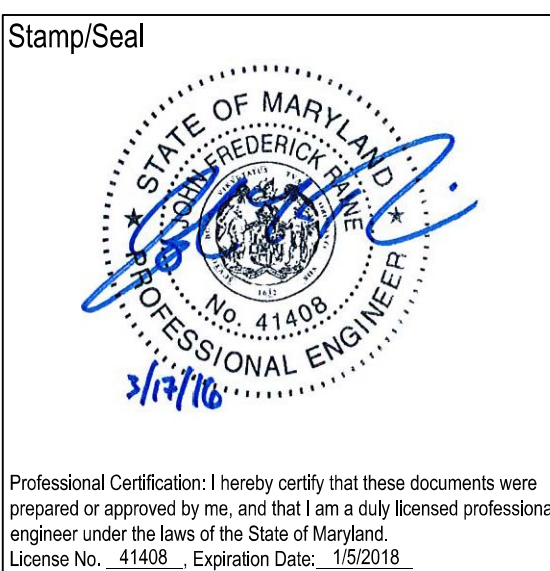

Approved:	Approved: Chief, Facilities and Engineering
	Approved: Associate Chief for Maintenance And Operations, Perry Point
	Approved: Engineering Projects Supervisor
	Approved: Infection Control Officer

Drawing Title
ELECTRICAL SITE PLAN - DEMOLITION AND NEW WORK
Approved: Associate Director for Operations
Approved: Director, Medical Center

FULLY SPRINKLERED

Project Title	Date
WAREHOUSE RENOVATION & EXPANSION	03/17/16
Scale	Building Number
AS NOTED	360
Checked	JFR
Drawn	MLS
Location	Drawing Number
PERRY POINT, MD	E002

VA Project Number
512-530
DEPARTMENT OF VETERANS AFFAIRS

DRAWING NOTES: (APPLICABLE TO THIS SHEET ONLY)
D1. EXISTING SHOWN WITH LIGHT WEIGHT LINE, _____
D2. NEW WORK SHOWN WITH HEAVY WEIGHT LINE, _____

SPECIAL NOTES: (APPLICABLE TO THIS SHEET ONLY)
① ALL ELECTRICAL WORK IN THIS AREA SHALL BE REMOVED IN ITS ENTIRETY, UNLESS OTHERWISE NOTED. THIS REMOVAL SHALL INCLUDE LIGHTING FIXTURES AND ASSOCIATED SWITCHES, RECEPTACLES, PANELBOARDS, TELEPHONE TERMINAL BOARDS, SIGNAL AND COMMUNICATION DEVICES, JUNCTION BOXES, WIRING AND CONDUIT, ETC. WIRING SHALL BE REMOVED BACK TO SOURCE AND CONDUITS SHALL BE REMOVED BACK TO POINT OF CONCEALMENT, UNLESS OTHERWISE NOTED.

EXISTING UNIT 360-AH2 TO REMAIN. EXISTING ELECTRICAL CONNECTIONS FROM VFD TO MOTOR TO REMAIN. REMOVE EXISTING WIRING AND CONDUIT BACK TO SOURCE AND MAKE CONNECTION TO NEW PANEL HM2B AS INDICATED ON DRAWING E202.

EXISTING UNIT 360-AH1 TO REMAIN. EXISTING ELECTRICAL CONNECTIONS FROM VFD TO MOTOR TO REMAIN. REMOVE EXISTING WIRING AND CONDUIT BACK TO SOURCE AND MAKE CONNECTION TO NEW PANEL HM2B AS INDICATED ON DRAWING E202.

EXISTING UNIT 360-AH3 TO REMAIN. EXISTING ELECTRICAL CONNECTIONS FROM VFD TO MOTOR TO REMAIN. REMOVE EXISTING WIRING AND CONDUIT BACK TO SOURCE AND MAKE CONNECTION TO NEW PANEL HM2B AS INDICATED ON DRAWING E202.

MEZZANINE AND UPPER LEVEL PLAN - ELECTRICAL DEMOLITION

SCALE: 1/8" = 1'-0"



Additions:	Date
Revisions:	Date
SCHEMATIC DESIGN (30%) SUBMISSION	03/25/15
DESIGN DEVELOPMENT (60%) SUBMISSION	09/11/15
CONSTRUCTION DOCUMENTS (90% SUBMISSION)	11/23/15
BID DOCUMENTS	03/17/16

ARCHITECT / ENGINEERS / CONSULTANTS:


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Fax:



Approved:	

Approved: Chief, Facilities and Engineering
Approved: Associate Chief for Maintenance And Operations, Perry Point
Approved: Engineering Projects Supervisor
Approved: Infection Control Officer

Drawing Title
MEZZANINE AND UPPER LEVEL - ELECTRICAL DEMOLITION
Approved: Associate Director for Operations
Approved: Director, Medical Center

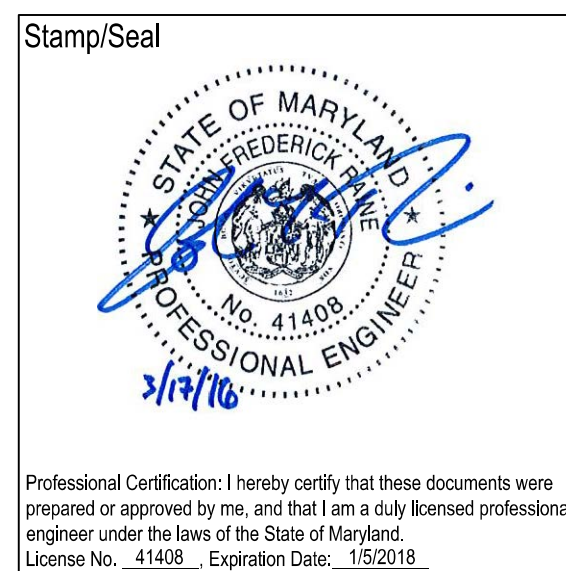FULLY SPRINKLERED

Project Title
WAREHOUSE RENOVATION & EXPANSION
Scale
AS NOTED
Building Number
360
Checked
JFR
Drawn
MLS
Location
PERRY POINT, MD

Date
03/17/16
VA Project Number
512-530
Drawing Number
ED101



DRAWING NOTES: (APPLICABLE TO THIS SHEET ONLY)
D1. EXISTING SHOWN WITH LIGHT WEIGHT LINE.
D2. NEW WORK SHOWN WITH HEAVY WEIGHT LINE.
D3. PROVIDE UNSWITCHED HOT LEG TO EMERGENCY BATTERY BALLASTS FOR CHARGING AND TO SENSE LOSS OF NORMAL POWER OPERATION.

MATCHLINE SEE DWG E101 FOR CONTINUATION

REROUTE CIRCUITS IN THIS AREA TO NEW PANEL LR1C. CONTRACTOR TO FIELD VERIFY CIRCUIT NUMBERS AND LABEL EACH SWITCH WITH NEW PANEL AND CIRCUIT INFORMATION


GROUND FLOOR PART PLAN - ELECTRICAL NEW WORK - LIGHTING

SCALE: 1/8" = 1'-0"



Additions:	Date
Revisions:	Date
SCHEMATIC DESIGN (30%) SUBMISSION	03/25/15
DESIGN DEVELOPMENT (60%) SUBMISSION	09/11/15
CONSTRUCTION DOCUMENTS (90% SUBMISSION)	11/23/15
BID DOCUMENTS	03/17/16

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Approved:	Approved: Chief, Facilities and Engineering
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	Approved: Engineering Projects Supervisor
	Approved: Infection Control Officer

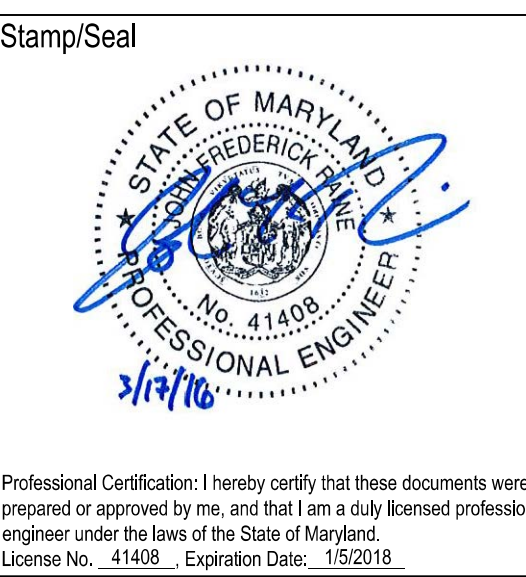
Drawing Title
GROUND FLOOR PART PLAN - ELECTRICAL NEW WORK
Approved: Associate Director for Operations
Approved: Director, Medical Center

FULLY SPRINKLERED

Project Title	Date
WAREHOUSE RENOVATION & EXPANSION	03/17/16
Scale	Building Number
AS NOTED	360
Checked	JFR
Drawn	MLS
Location	Drawing Number
PERRY POINT, MD	E100

VA Project Number
512-530
Drawing Number
E100



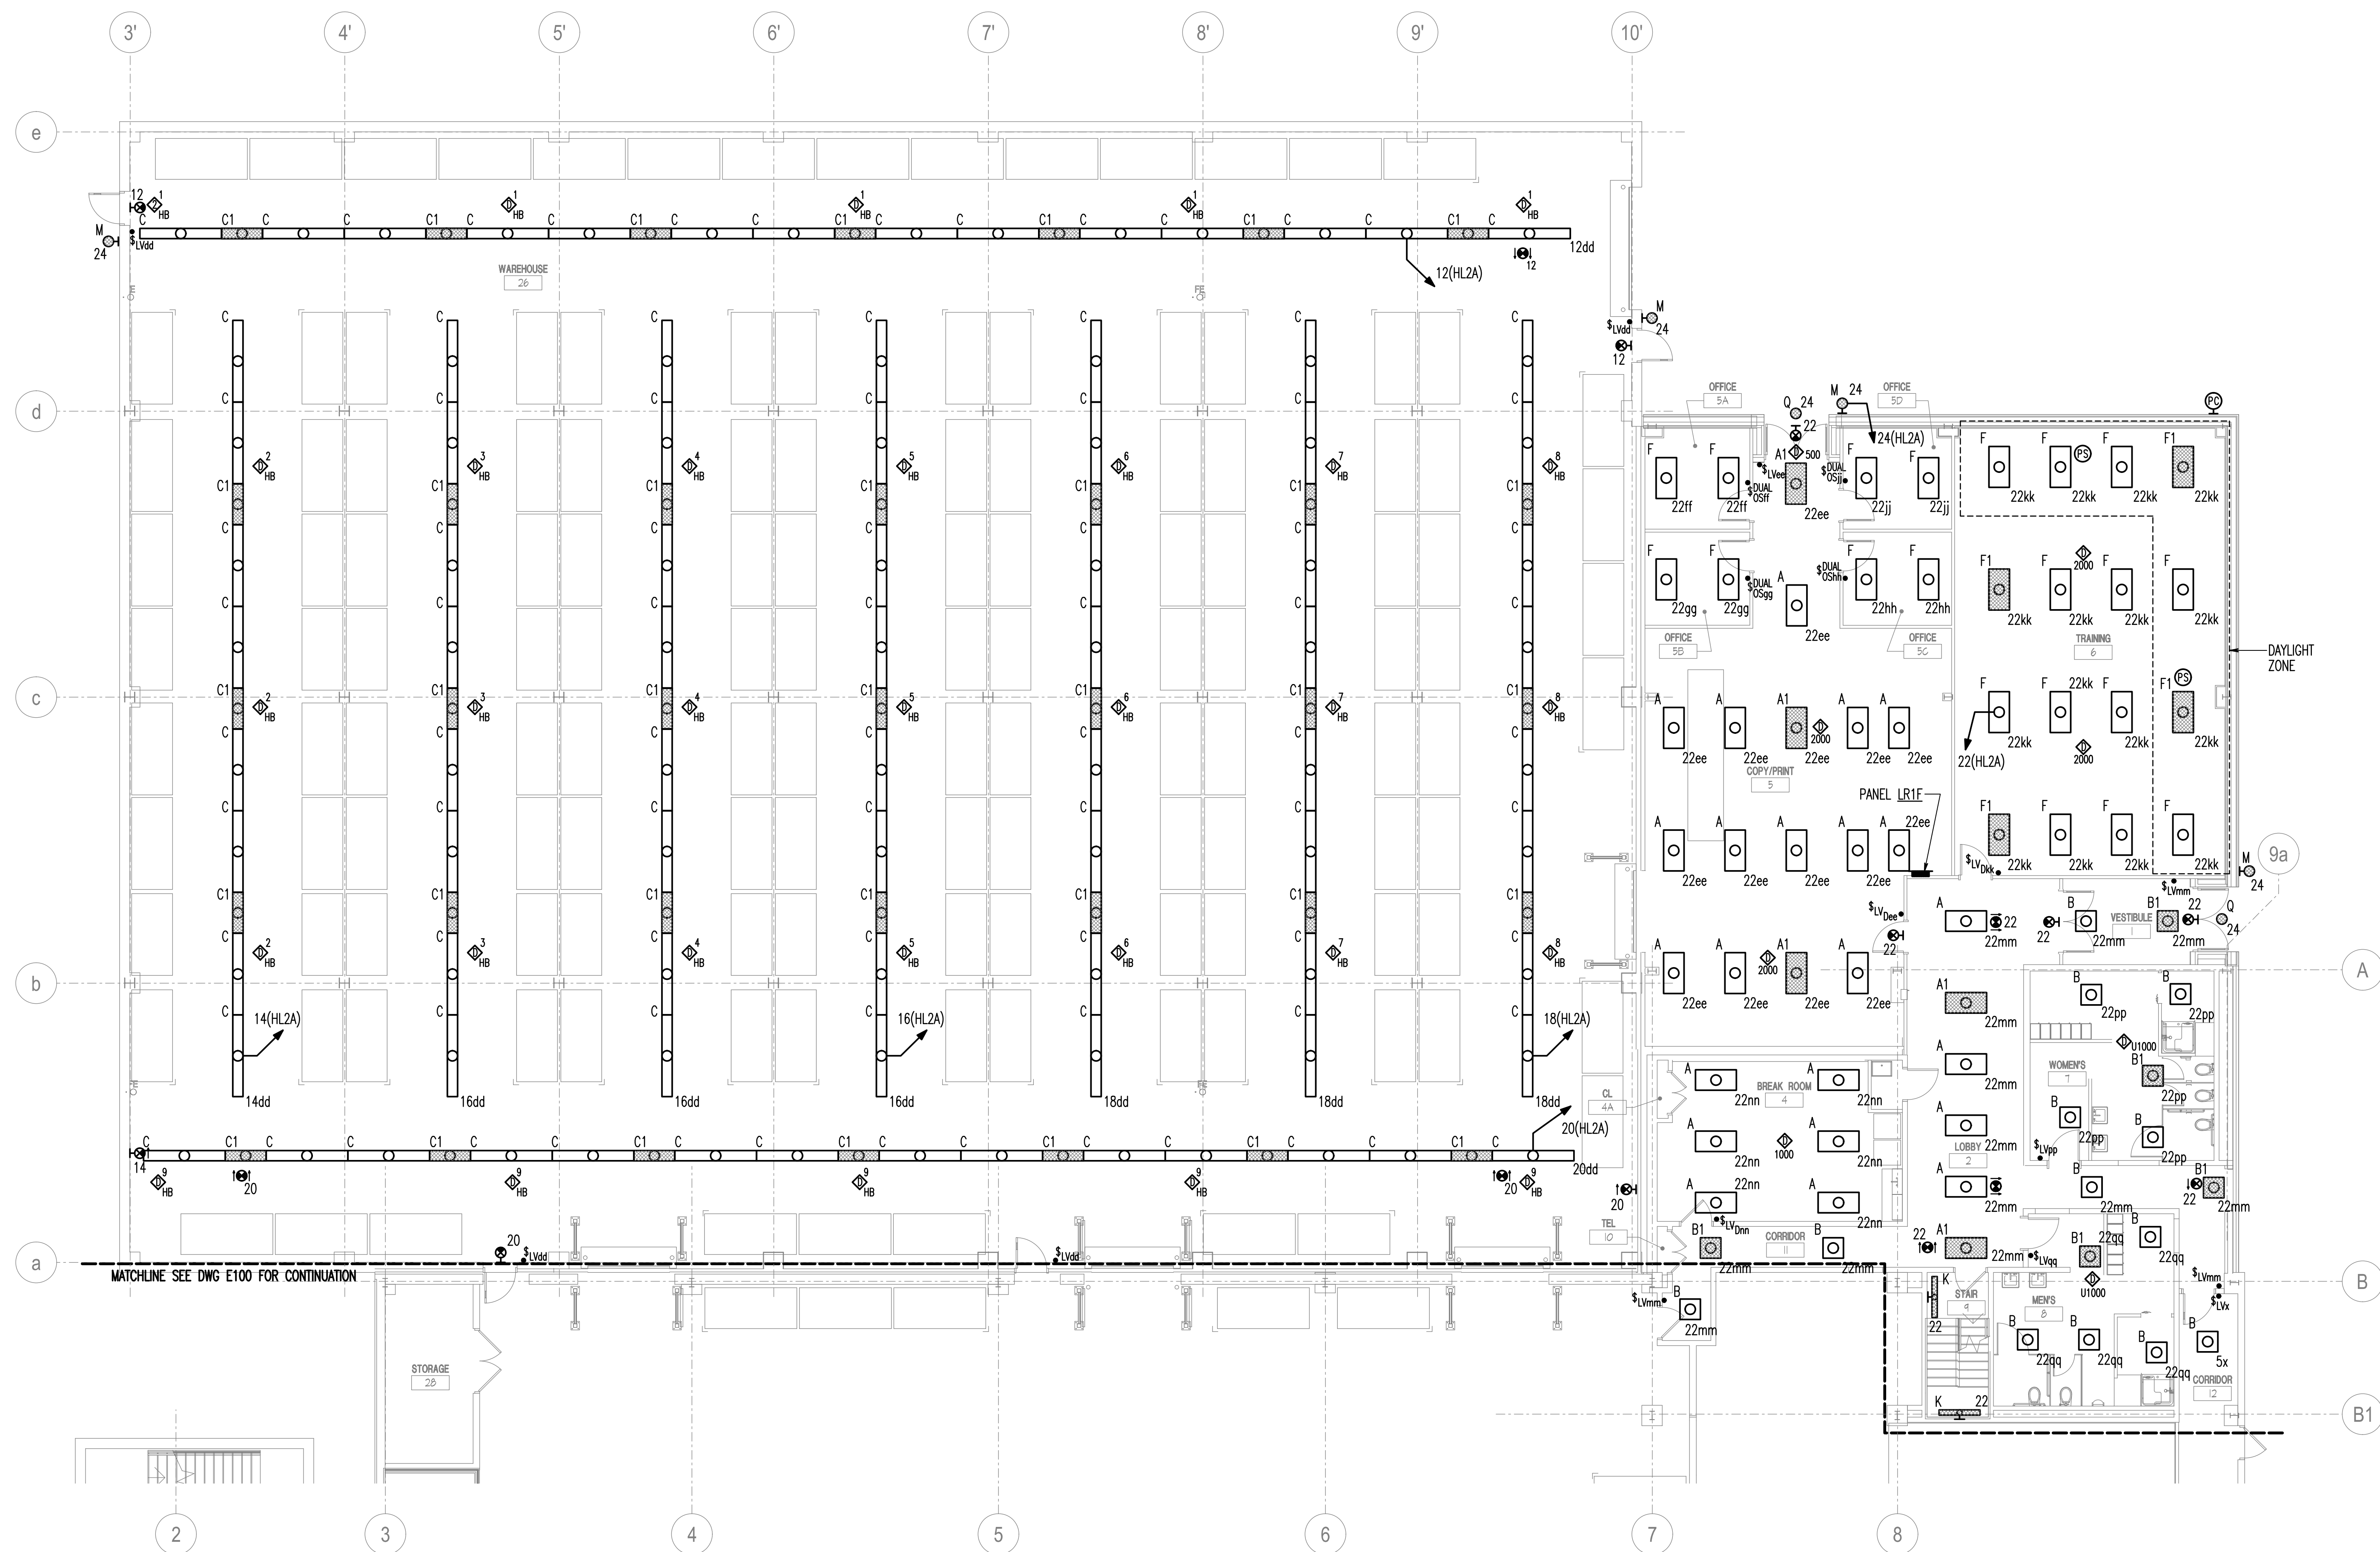


1 GROUND FLOOR PART PLAN - ELECTRICAL NEW WORK - LIGHTING
SCALE: 1/8" = 1'-0"

Additional:	Date
Revisions:	Date
SCHEMATIC DESIGN (30%) SUBMISSION	03/25/15
DESIGN DEVELOPMENT (60%) SUBMISSION	09/11/15
CONSTRUCTION DOCUMENTS (90% SUBMISSION)	11/23/15
BID DOCUMENTS	03/17/16

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Approved:	Approved: Chief, Facilities and Engineering
	Approved: Associate Chief for Maintenance And Operations, Perry Point
	Approved: Engineering Projects Supervisor
	Approved: Infection Control Officer

Drawing Title	
GROUND FLOOR PART PLAN - LIGHTING	
Approved: Associate Director for Operations	
Approved: Director, Medical Center	

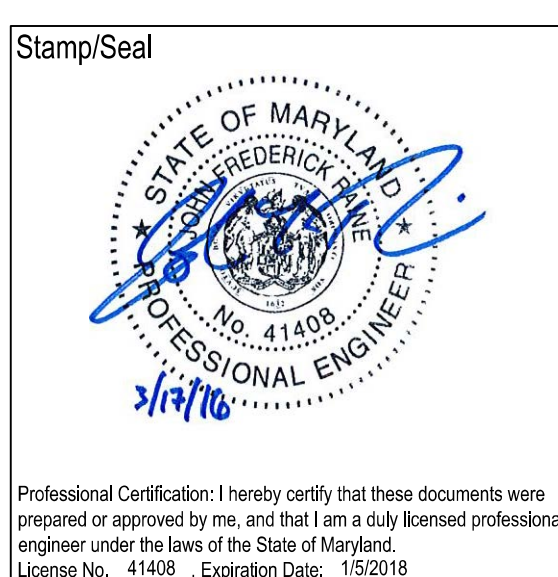
FULLY SPRINKLERED

Project Title			
WAREHOUSE RENOVATION & EXPANSION			
Scale	Building Number	Checked	Drawn
AS NOTED	360	JFR	MLS
Location			
PERRY POINT, MD			



DRAWING NOTES: (APPLICABLE TO THIS SHEET ONLY)
D1. EXISTING SHOWN WITH LIGHT WEIGHT LINE, _____
D2. NEW WORK SHOWN WITH HEAVY WEIGHT LINE, _____

SPECIAL NOTES: (APPLICABLE TO THIS SHEET ONLY)
① FOR FAN F-C6. MOUNT ON CEILING AT PENDANT.
② FOR OVERHEAD COILING DOOR. PROVIDE EMPTY BACKBOX AND CONDUIT TO DOOR OPERATOR FOR CONTROLS BY OTHERS.
③ ROLL UP GENERATOR CONNECTION CABINET. REFER TO 6/E503 FOR MOUNTING INFORMATION. REFER TO SINGLE LINE DIAGRAM E600 FOR FURTHER INFORMATION.
④ MAKE ALL 120V CONNECTIONS TO POWER DOOR OPERATOR.

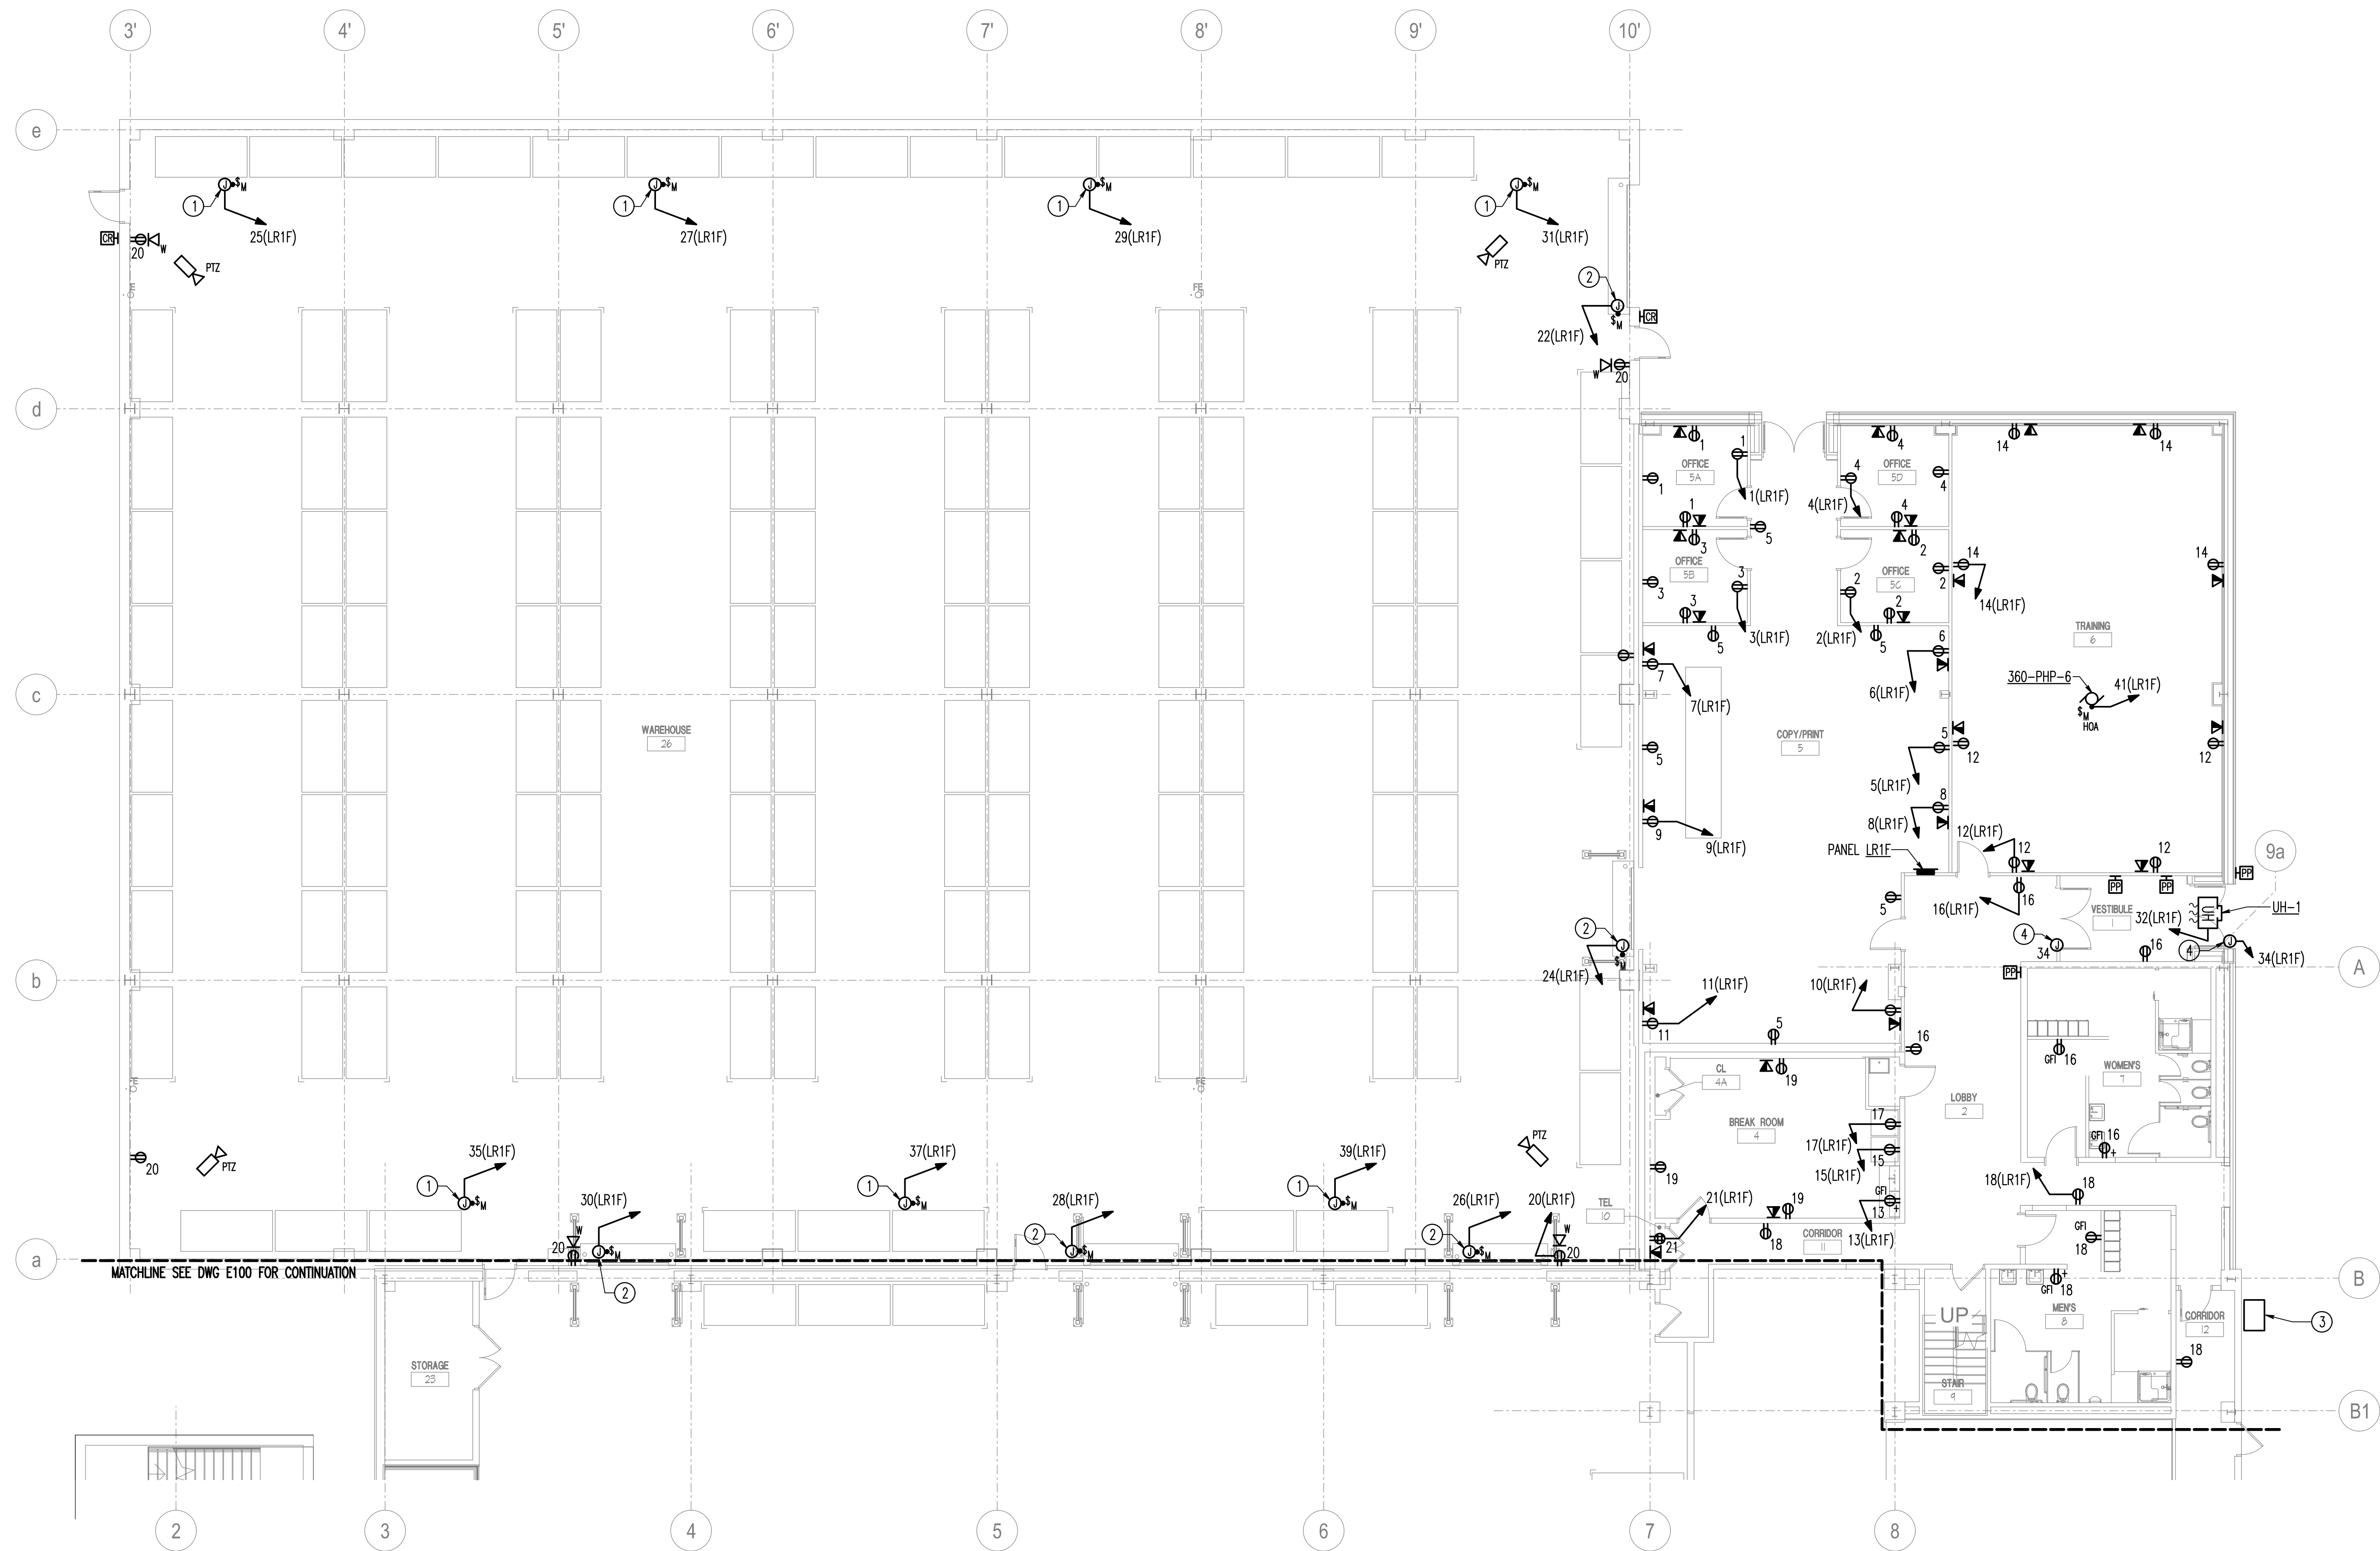

① GROUND FLOOR PART PLAN - ELECTRICAL NEW WORK - POWER AND COMMUNICATIONS
SCALE: 1/8" = 1'-0"

Additions:	Date
Revisions:	Date
SCHEMATIC DESIGN (30%) SUBMISSION	03/25/15
DESIGN DEVELOPMENT (60%) SUBMISSION	09/11/15
CONSTRUCTION DOCUMENTS (90% SUBMISSION)	11/23/15
BID DOCUMENTS	03/17/16

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Approved: _____

Approved: Chief, Facilities and Engineering

Approved: Associate Chief for Maintenance And Operations, Perry Point

Approved: Engineering Projects Supervisor

Approved: Infection Control Officer

Approved: Chief, Facilities and Engineering

Approved: Associate Chief for Maintenance And Operations, Perry Point

Approved: Engineering Projects Supervisor

Approved: Infection Control Officer

Drawing Title

GROUND FLOOR PART PLAN - POWER AND COMMUNICATIONS

Approved: Associate Director for Operations

Approved: Director, Medical Center

FULLY SPRINKLERED

Project Title: **WAREHOUSE RENOVATION & EXPANSION**

Date: **03/17/16**

VA Project Number: **512-530**

Drawing Number: **E201**

Scale: **AS NOTED**

Building Number: **360**

Checked: **JFR**


Drawn: **MLS**

Location: **PERRY POINT, MD**

DEPARTMENT OF VETERANS AFFAIRS

DRAWING NOTES: (APPLICABLE TO THIS SHEET ONLY)
D1. EXISTING SHOWN WITH LIGHT WEIGHT LINE,
D2. NEW WORK SHOWN WITH HEAVY WEIGHT LINE,

SPECIAL NOTES: (APPLICABLE TO THIS SHEET ONLY)
1 SEE PART PLAN ON DRAWING 1/E400 FOR ELECTRICAL WORK IN THIS AREA.
2 FOR FAN F-C6. MOUNT ON CEILING AT PENDANT.
3 MAKE ALL FINAL CONNECTIONS TO CIRCULATION FAN CONTROL PANEL.

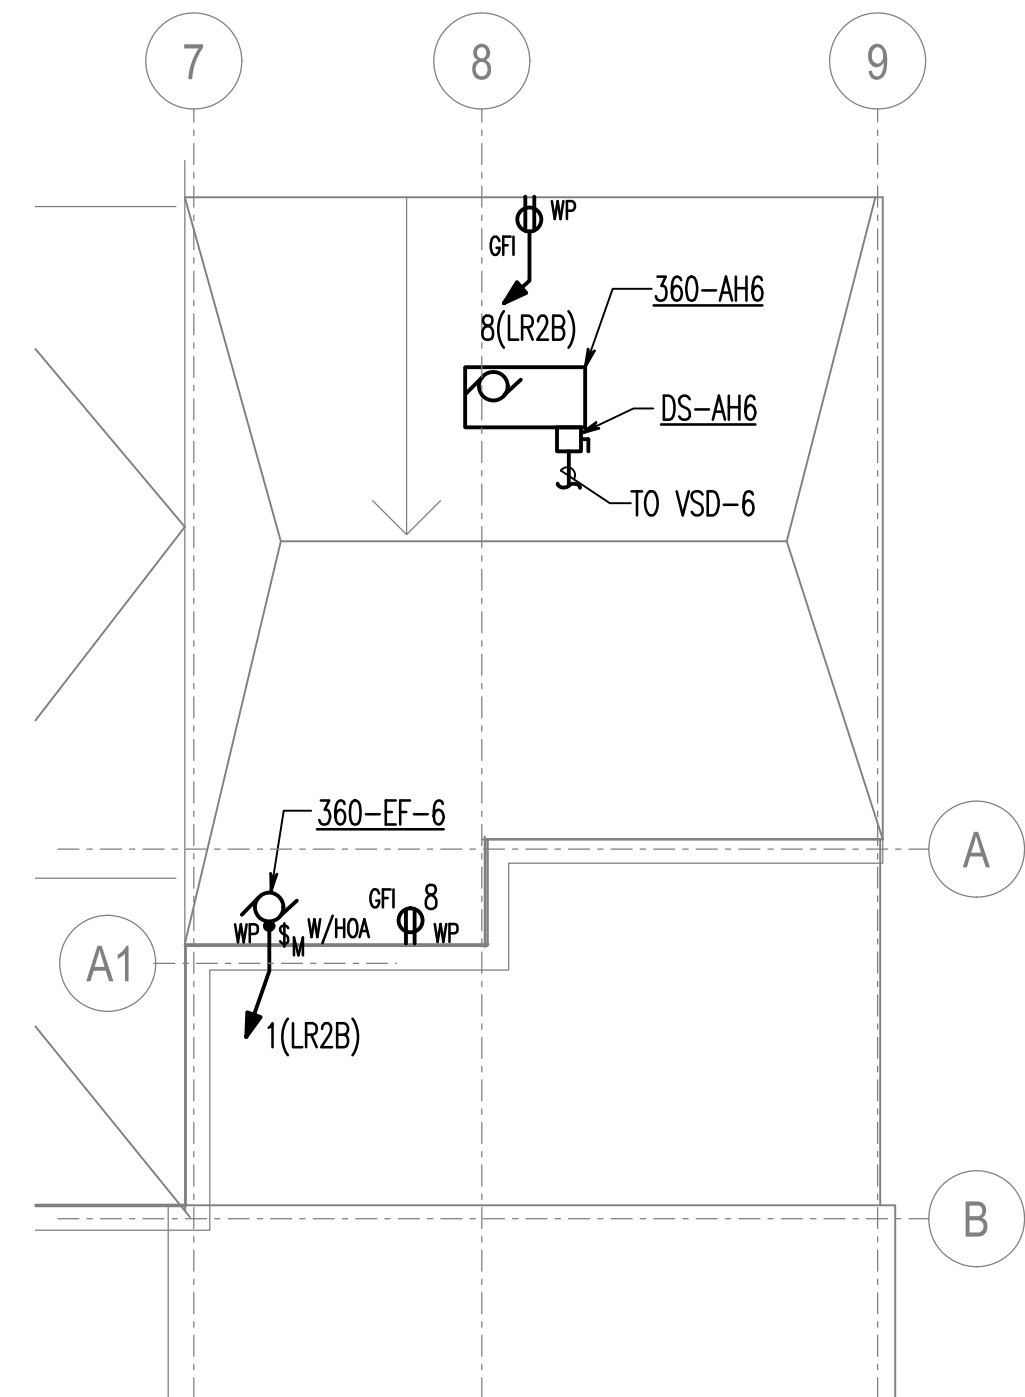

2 ROOF- MECHANICAL NEW WORK
SCALE: 1/16" = 1'-0"

1 MEZZANINE- ELECTRICAL NEW WORK - POWER AND COMMUNICATIONS
SCALE: 1/8" = 1'-0"

Additions:	Date
Revisions:	Date
SCHEMATIC DESIGN (30%) SUBMISSION	03/25/15
DESIGN DEVELOPMENT (60%) SUBMISSION	09/11/15
CONSTRUCTION DOCUMENTS (90% SUBMISSION)	11/23/15
BID DOCUMENTS	03/17/16

ARCHITECT / ENGINEERS / CONSULTANTS:


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Fax:



Approved: _____

Approved: Chief, Facilities and Engineering

Approved: Associate Chief for Maintenance And Operations, Perry Point

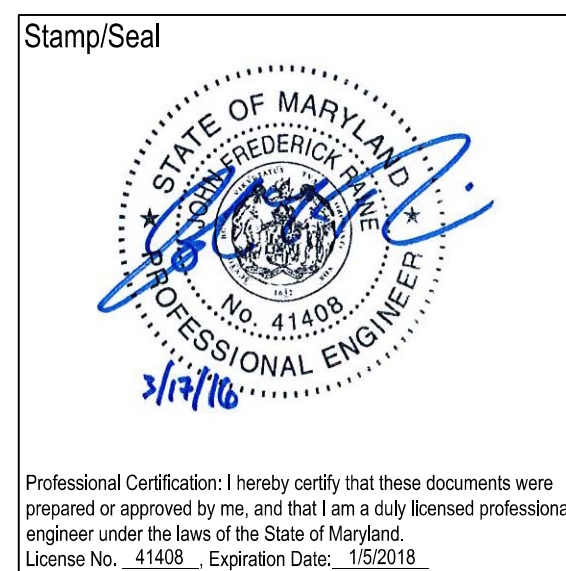Approved: Engineering Projects Supervisor

Approved: Infection Control Officer

Approved: Chief, Facilities and Engineering

Approved: Associate Chief for Maintenance And Operations, Perry Point

Approved: Engineering Projects Supervisor

Approved: Infection Control Officer

Drawing Title
MEZZANINE - POWER AND COMMUNICATIONS

Approved: Associate Director for Operations

Approved: Director, Medical Center

FULLY SPRINKLERED

Project Title
WAREHOUSE RENOVATION & EXPANSION

Scale
AS NOTED

Building Number
360

Checked
JFR

Drawn
MLS

Location
PERRY POINT, MD

Date
03/17/16

VA Project Number
512-530

Drawing Number
E202



THREE INCHES = ONE FOOT (3" = 1'-0")

ONE AND ONE HALF INCHES = ONE FOOT (1 1/2" = 1'-0")

ONE INCH = ONE FOOT (1" = 1'-0")


THREE QUARTERS INCH = ONE FOOT (3/4" = 1'-0")

ONE HALF INCH = ONE FOOT (1/2" = 1'-0")

THREE EIGHTHS INCH = ONE FOOT (3/8" = 1'-0")

ONE QUARTER INCH = ONE FOOT (1/4" = 1'-0")

ONE EIGHTH INCH = ONE FOOT (1/8" = 1'-0")

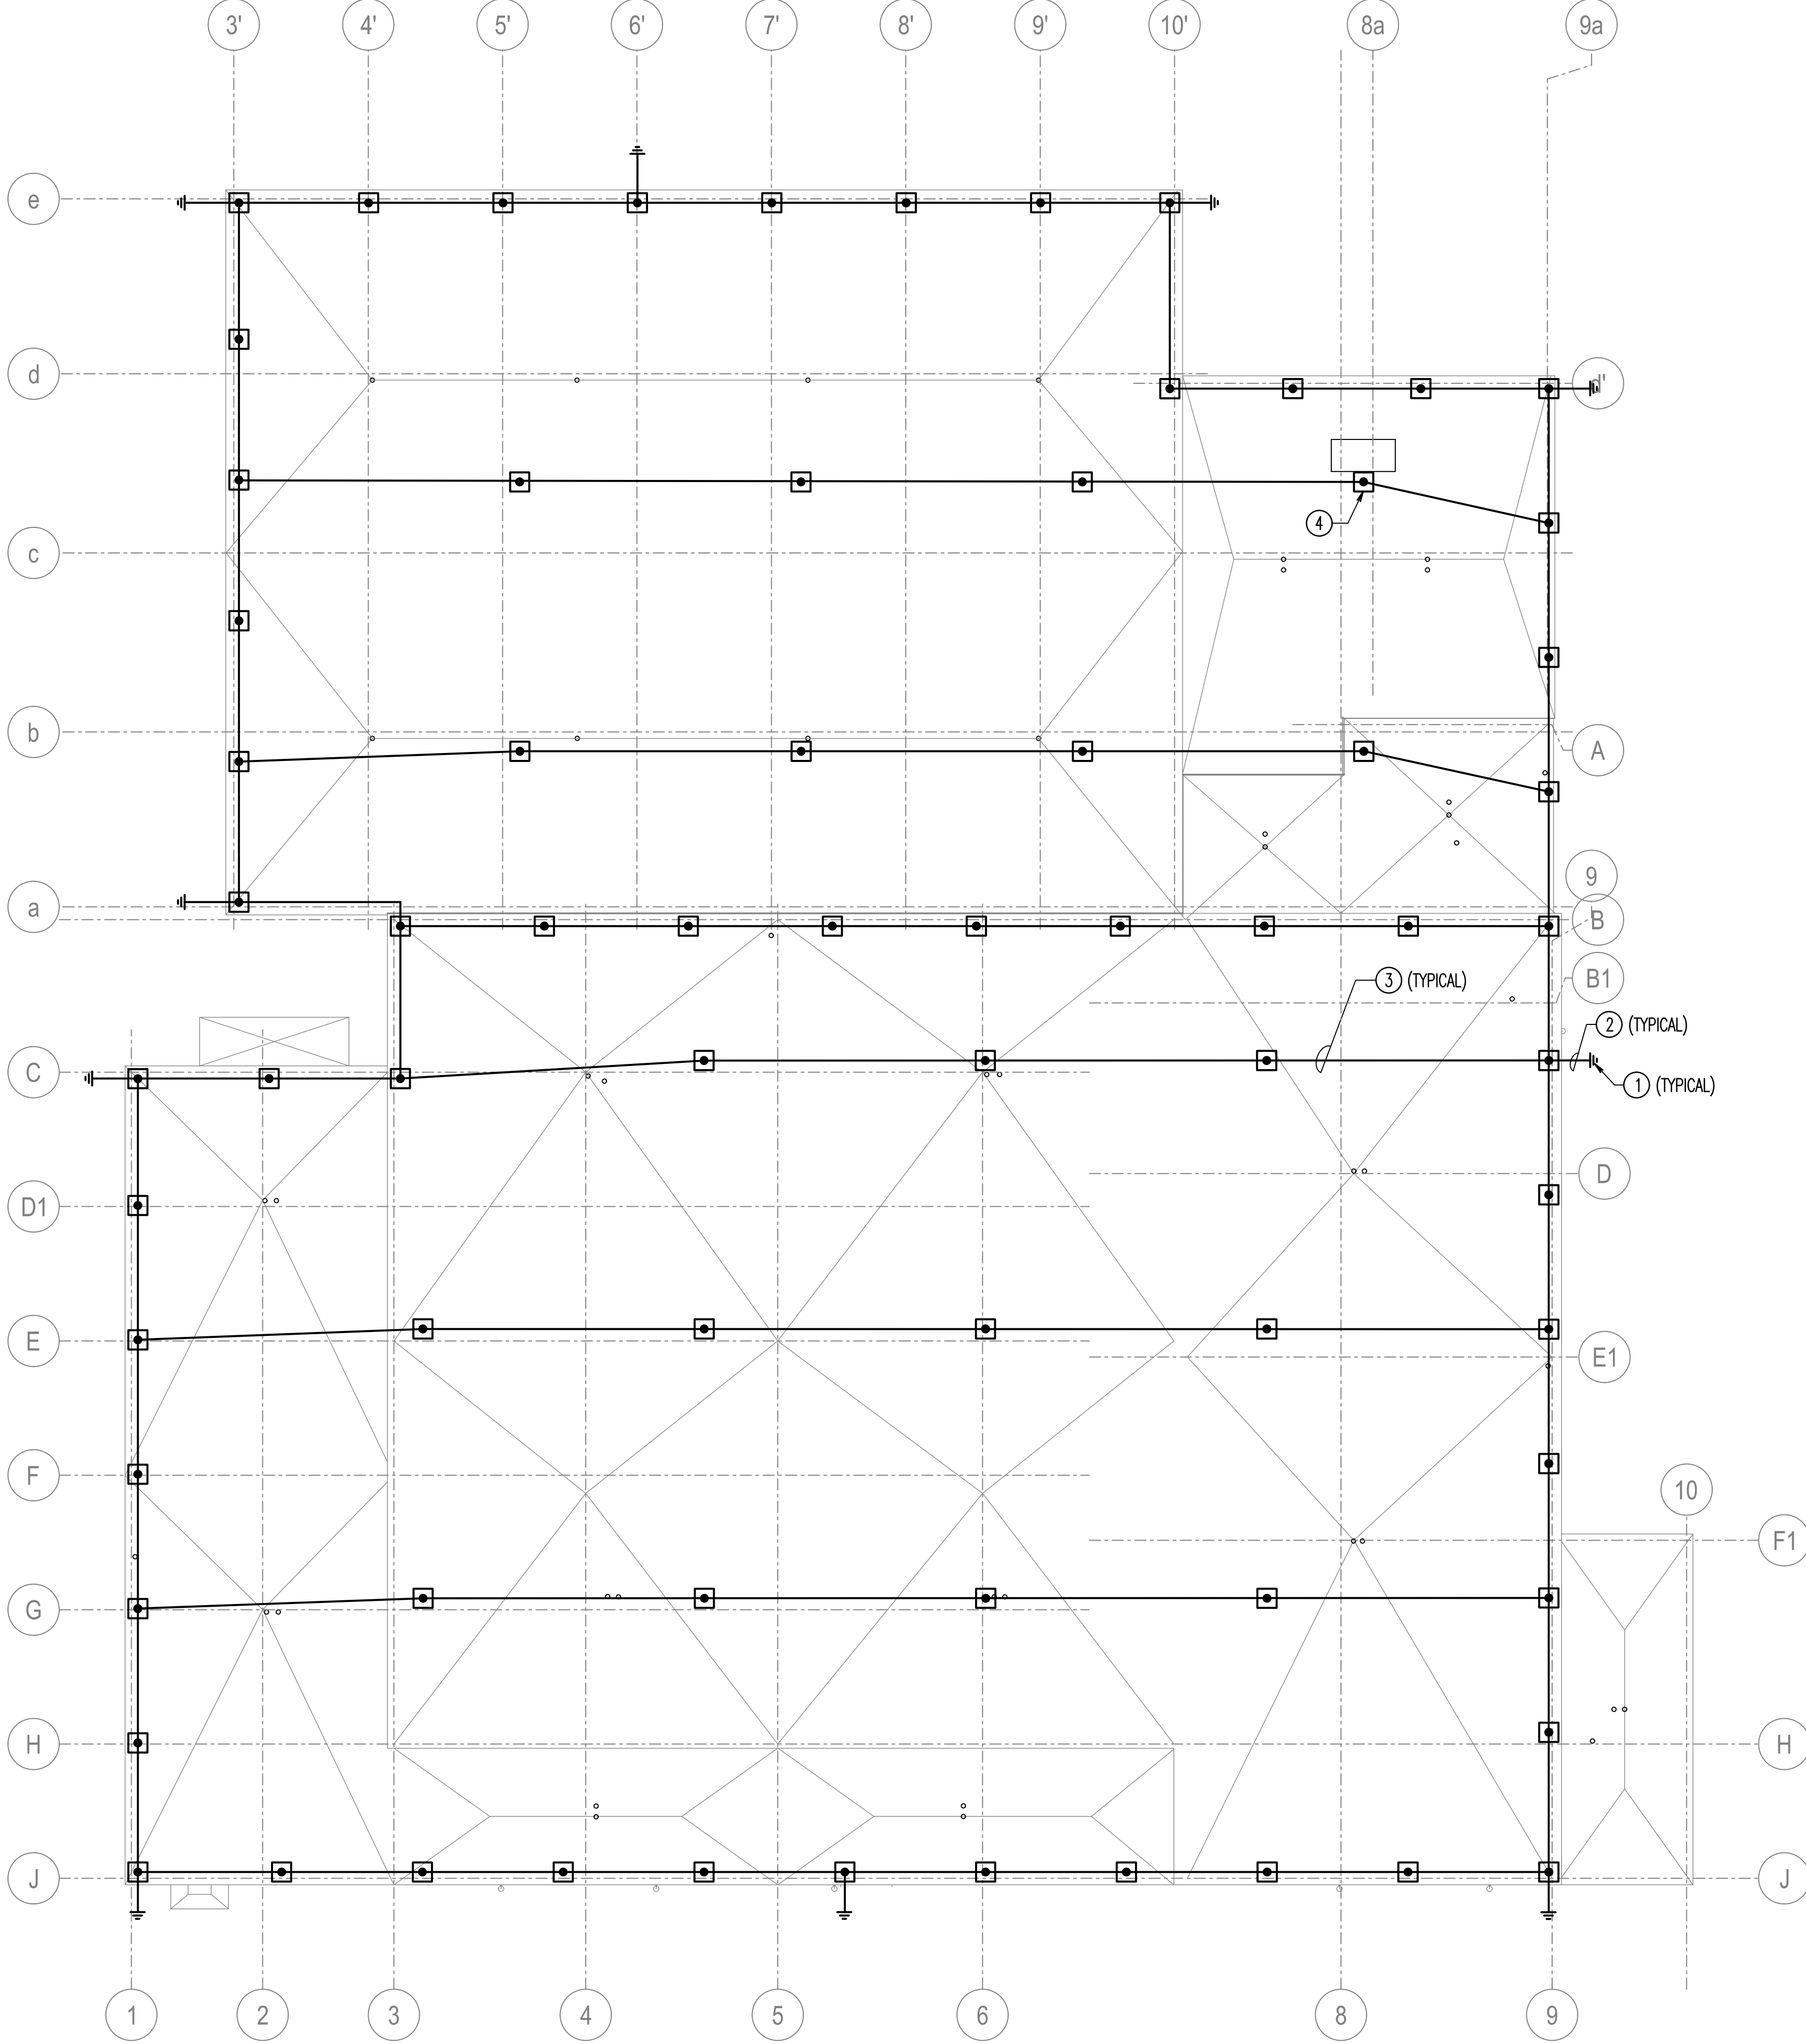

1 ROOF PLAN - ELECTRICAL NEW WORK - LIGHTNING PROTECTION
SCALE: 1/16" = 1'-0"

- DRAWING NOTES: (APPLICABLE TO THIS SHEET ONLY)
- D1. THE LIGHTNING PROTECTION SYSTEM SHALL BE DESIGNED AND INSTALLED BY A LIGHTNING PROTECTION INSTITUTE CERTIFIED MASTER DESIGNER/INSTALLER. INSTALLED DESIGN SHALL BE SUBMITTED AS SHOP DRAWING FOR APPROVAL.
 - D2. THE DESIGN AND INSTALLATION OF THE LIGHTNING PROTECTION SYSTEM SHALL MEET THE REQUIREMENTS OF LPI-176 STANDARD OF PRACTICE AND UL-96, UL-96A AND NFPA-780.
 - D3. NEW LIGHTNING PROTECTION SYSTEM SHALL INCORPORATE EXISTING LIGHTNING PROTECTION COMPONENTS ON EXISTING ROOF AND WHEN COMPLETE, ENTIRE ROOF (NEW AND EXISTING) SHALL HAVE NEW COMPREHENSIVE UL MASTER LABEL.
 - D4. PROVIDE A UL MASTER LABEL FOR THE LIGHTNING PROTECTION SYSTEM OF THE ENTIRE BUILDING. PROVIDE ANY ADDITIONAL CABLE, CONNECTIONS, AIR TERMINALS, MISCELLANEOUS HARDWARE AND ACCESSORIES AS REQUIRED TO OBTAIN THE UL MASTER LABEL.
 - D5. PROVIDE LIGHTNING PROTECTION SYSTEM BONDING TO ALL METAL BODIES ON THE ROOF AS REQUIRED BY NFPA 780, INCLUDING BUT NOT LIMITED TO THE FOLLOWING: METAL ROOF, MECHANICAL SYSTEM COMPONENTS, FLASHINGS, GUTTERS, LADDERS.
 - D6. WHERE DISSIMILAR METALS ARE BONDED OR CONNECTED, PROVIDE A BI-METALLIC CONNECTOR.
 - D7. ALL CONNECTIONS TO THE COUNTER POISE GROUND LOOP AROUND BUILDING SHALL BE BELOW GRADE AND UTILIZE EXOTHERMIC WELD CONNECTIONS. MINIMUM 36" BFG.
 - D8. PROVIDE ALUMINUM MAIN CONDUCTORS ON ROOFS AND COPPER DOWN CONDUCTORS FROM ROOF TO THE CONNECTION TO THE UNDERGROUND COUNTER POISE GROUND LOOP.

- SPECIAL NOTES: (APPLICABLE TO THIS SHEET ONLY)
- 1 PROVIDE 10'-0" LONG X 3/4" DIAMETER COPPERCLAD STEEL GROUND ROD. EXOTHERMIC WELD TO LIGHTNING PROTECTION GROUND DOWN CONDUCTOR. BOND GROUND ROD TO GROUND RING. REFER TO DETAIL 8/E502.
 - 2 LIGHTNING PROTECTION SYSTEM DOWN CONDUCTOR IN 1" PVC SCH. 80 CONDUIT. CONCEAL CONDUIT IN EXTERIOR WALL. PROVIDE PITCH POCKETS OR EQUIVALENT MEANS TO SEAL PENETRATION. CONTRACTOR SHALL MAKE ALL PENETRATIONS WATERTIGHT.
 - 3 LIGHTNING PROTECTION SYSTEM CLASS 1 MAIN CONDUCTOR.
 - 4 AIR TERMINAL MOUNTED ON MECHANICAL EQUIPMENT.

Revisions:		Date:	
SCHEMATIC DESIGN (30%) SUBMISSION		03/25/15	
DESIGN DEVELOPMENT (60%) SUBMISSION		09/11/15	
CONSTRUCTION DOCUMENTS (90% SUBMISSION)		11/23/15	
BID DOCUMENTS		03/17/16	

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Stamp/Seal	Approved:	Approved: Chief, Facilities and Engineering
<small>Professional Certification: I hereby certify that these documents were prepared or approved by me, and that I am a duly licensed professional engineer under the laws of the State of Maryland. License No. 41408, Expiration Date: 11/30/18</small>		

Approved: Associate Chief for Maintenance And Operations, Perry Point	Approved: Engineering Projects Supervisor	Approved: Infection Control Officer


Drawing Title	
ROOF PLAN - ELECTRICAL NEW WORK - LIGHTNING PROTECTION	
Approved: Associate Director for Operations	
Approved: Director, Medical Center	

Project Title	
WAREHOUSE RENOVATION & EXPANSION	
Scale	Building Number
AS NOTED	360
Checked	Drawn
JFR	MLS
Location	
PERRY POINT, MD	

Date	VA Project Number	Drawing Number
03/17/16	512-530	E300

DEPARTMENT OF VETERANS AFFAIRS


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THREE QUARTERS INCH = ONE FOOT (3/4" = 1'-0")
ONE HALF INCH = ONE FOOT (1/2" = 1'-0")
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DRAWING NOTES: (APPLICABLE TO THIS SHEET ONLY)
D1. EXISTING SHOWN WITH LIGHT WEIGHT LINE, _____
D2. NEW WORK SHOWN WITH HEAVY WEIGHT LINE, _____

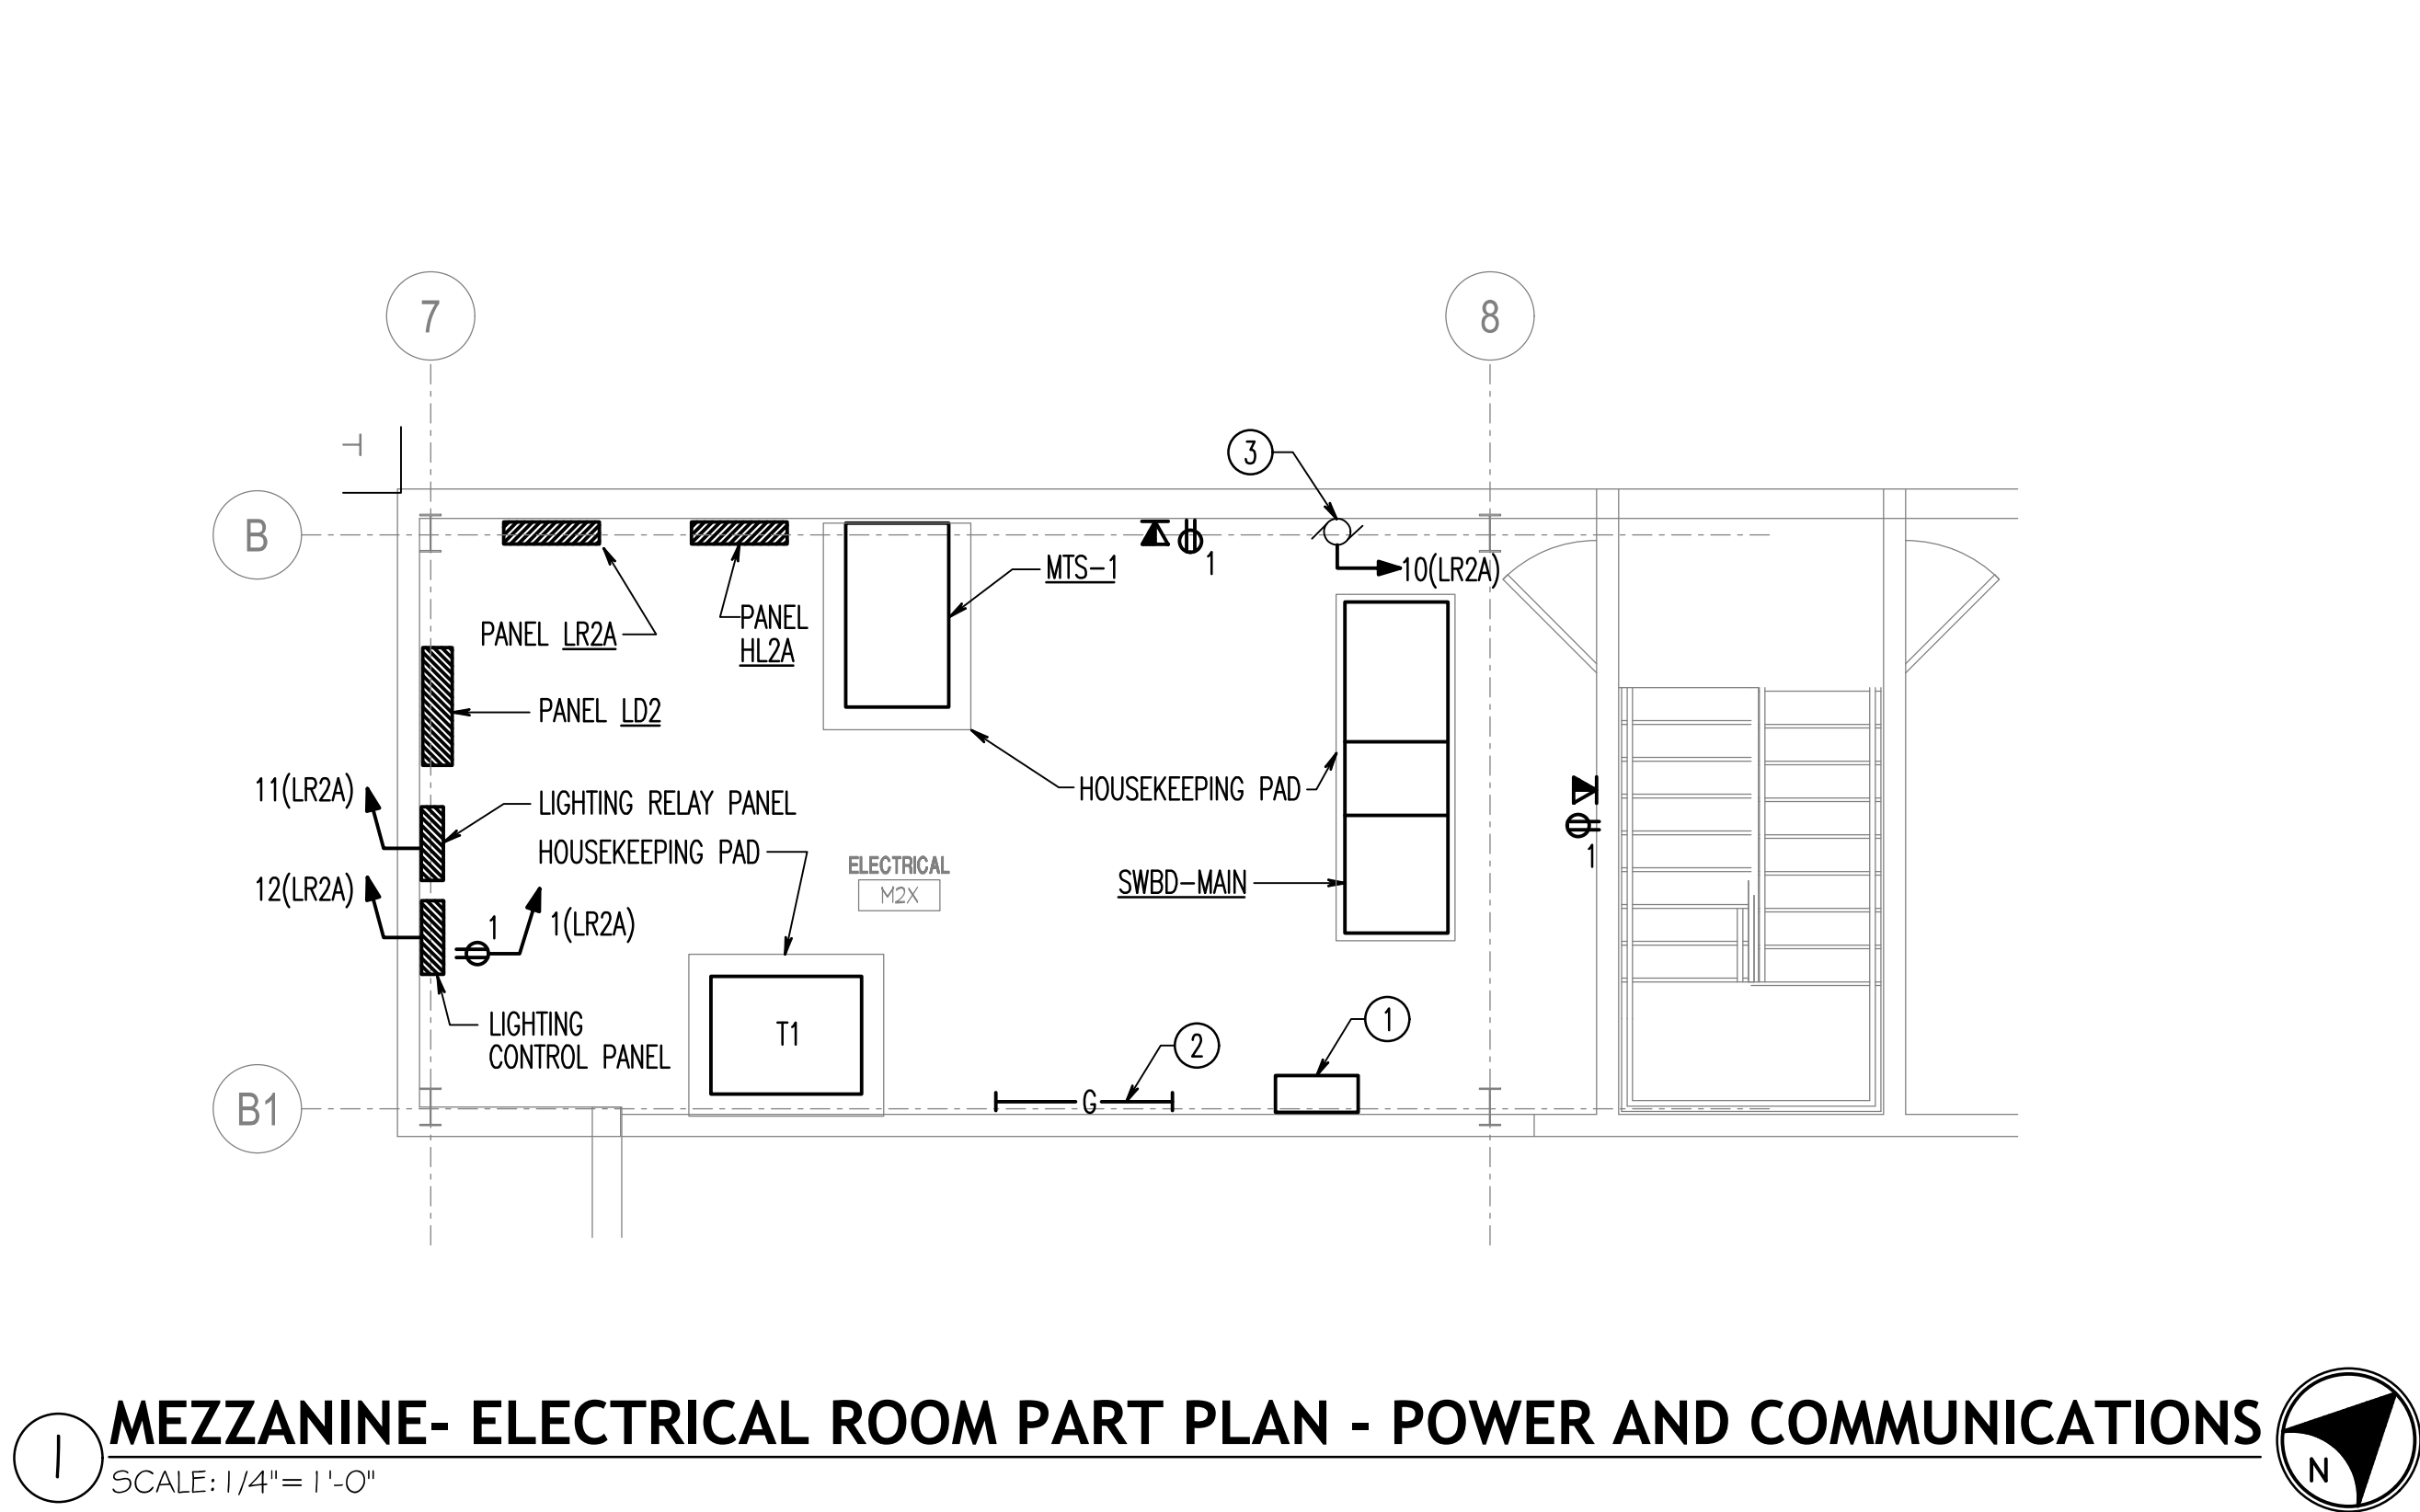SPECIAL NOTES: (APPLICABLE TO THIS SHEET ONLY)
① ENCLOSED CIRCUIT BREAKER FOR FIRE PUMP. REFER TO ONE LINE DIAGRAM FOR ADDITIONAL INFORMATION.
② MAIN GROUNDING BUS BAR. REFER TO DETAIL 1/E502 AND 1/E501.
③ MAKE ALL FINAL CONNECTIONS TO EXISTING RELIEF FAN.

MEZZANINE- ELECTRICAL ROOM PART PLAN - POWER AND COMMUNICATIONS
SCALE: 1/4" = 1'-0"



Stamp/Seal

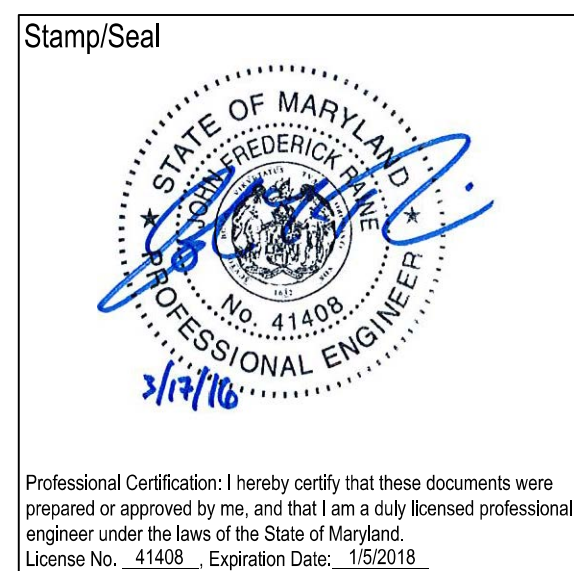Approved:

Approved: Chief, Facilities and Engineering

Approved: Associate Chief for Maintenance And Operations, Perry Point

Approved: Engineering Projects Supervisor

Approved: Infection Control Officer

Approved: Director, Medical Center

Drawing Title

ELECTRICAL PART PLANS

Project Title

WAREHOUSE RENOVATION & EXPANSION

Date

03/17/16

VA Project Number

512-530

Drawing Number

E400

Location

PERRY POINT, MD

Scale

AS NOTED

Building Number

360

Checked

JFR

Drawn

MLS

1/4" = 1' - 0"

0 2 4 8 12 FT

FULLY SPRINKLERED

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Stamp/Seal

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Approved: Engineering Projects Supervisor

Approved: Infection Control Officer

Approved: Director, Medical Center

Drawing Title

ELECTRICAL PART PLANS

Project Title

WAREHOUSE RENOVATION & EXPANSION

Date

03/17/16

VA Project Number

512-530

Drawing Number

E400

Location

PERRY POINT, MD

Scale

AS NOTED

Building Number

360

Checked

JFR

Drawn

MLS

1/4" = 1' - 0"

0 2 4 8 12 FT

FULLY SPRINKLERED

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Stamp/Seal

Approved:

Approved: Chief, Facilities and Engineering

Approved: Associate Chief for Maintenance And Operations, Perry Point

Approved: Engineering Projects Supervisor

Approved: Infection Control Officer

Approved: Director, Medical Center

Drawing Title

ELECTRICAL PART PLANS

Project Title

WAREHOUSE RENOVATION & EXPANSION

Date

03/17/16

VA Project Number

512-530

Drawing Number

E400

Location

PERRY POINT, MD

Scale

AS NOTED

Building Number

360

Checked

JFR

Drawn

MLS

1/4" = 1' - 0"

0 2 4 8 12 FT

FULLY SPRINKLERED

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The Protection Engineering Group
2809 Boston Street, Suite 7
Baltimore, MD 21224 USA
Tel: (443) 708-4096
Fax:

Professional Certification: I hereby certify that these documents were prepared or approved by me, and that I am a duly licensed professional engineer under the laws of the State of Maryland. License No. 41408, Expiration Date: 11/30/18.

Stamp/Seal

Approved:

Approved: Chief, Facilities and Engineering

Approved: Associate Chief for Maintenance And Operations, Perry Point

Approved: Engineering Projects Supervisor

Approved: Infection Control Officer

Approved: Director, Medical Center

Drawing Title

ELECTRICAL PART PLANS

Project Title

WAREHOUSE RENOVATION & EXPANSION

Date

03/17/16

VA Project Number

512-530

Drawing Number

E400

Location

PERRY POINT, MD

Scale

AS NOTED

Building Number

360

Checked

JFR

Drawn

MLS

1/4" = 1' - 0"

0 2 4 8 12 FT

FULLY SPRINKLERED

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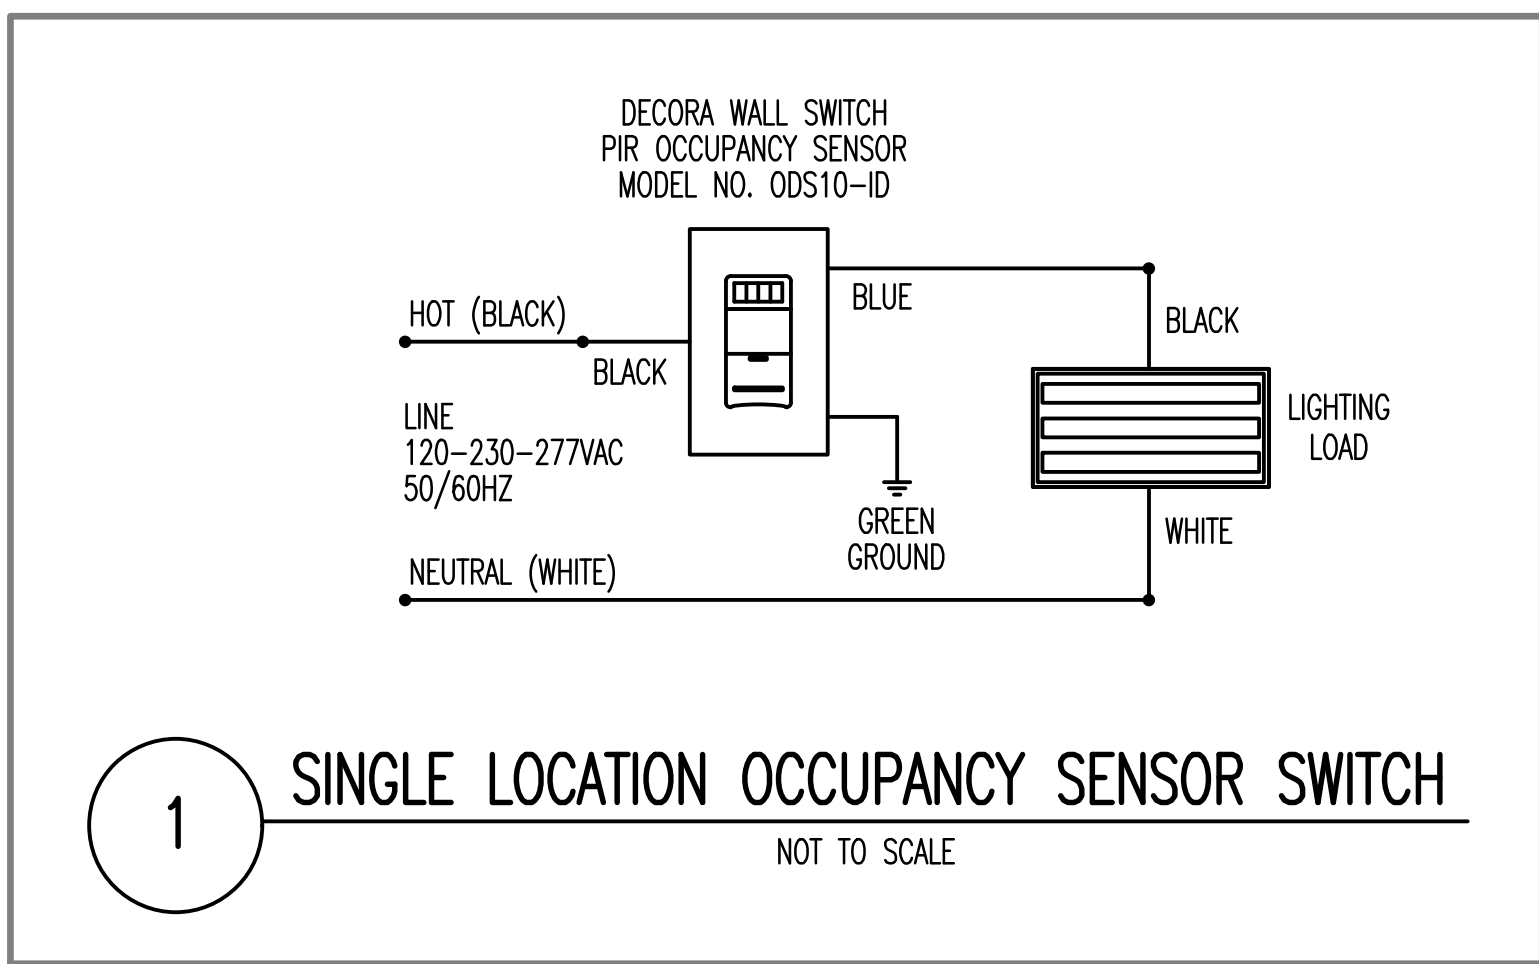
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Drawn


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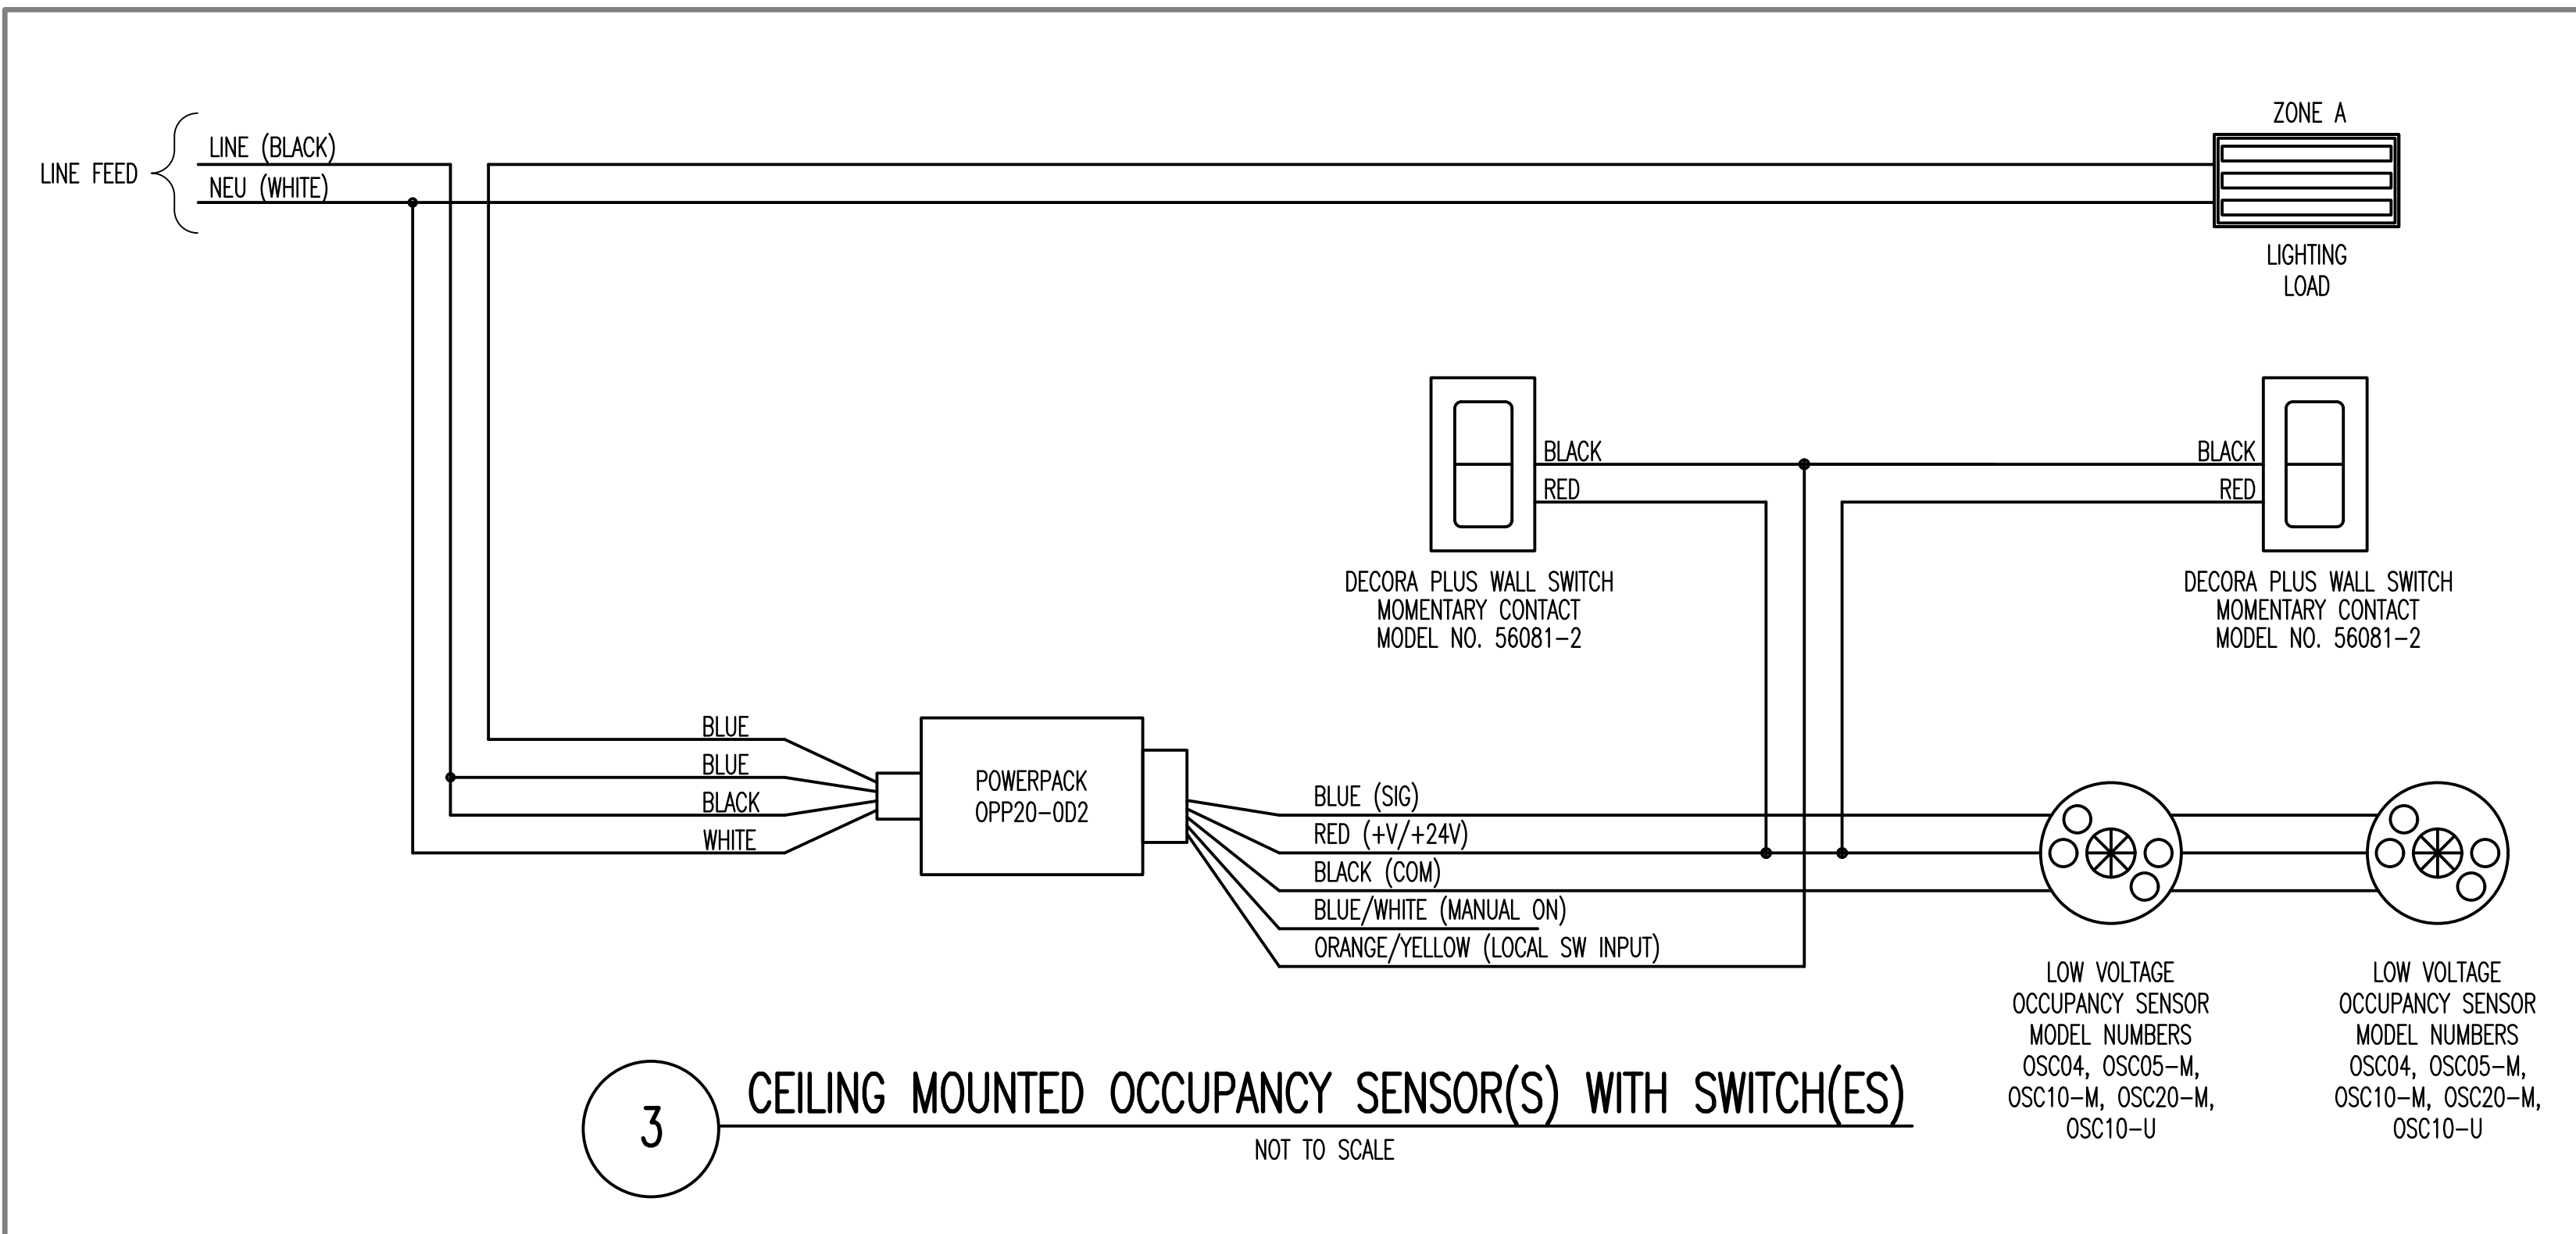
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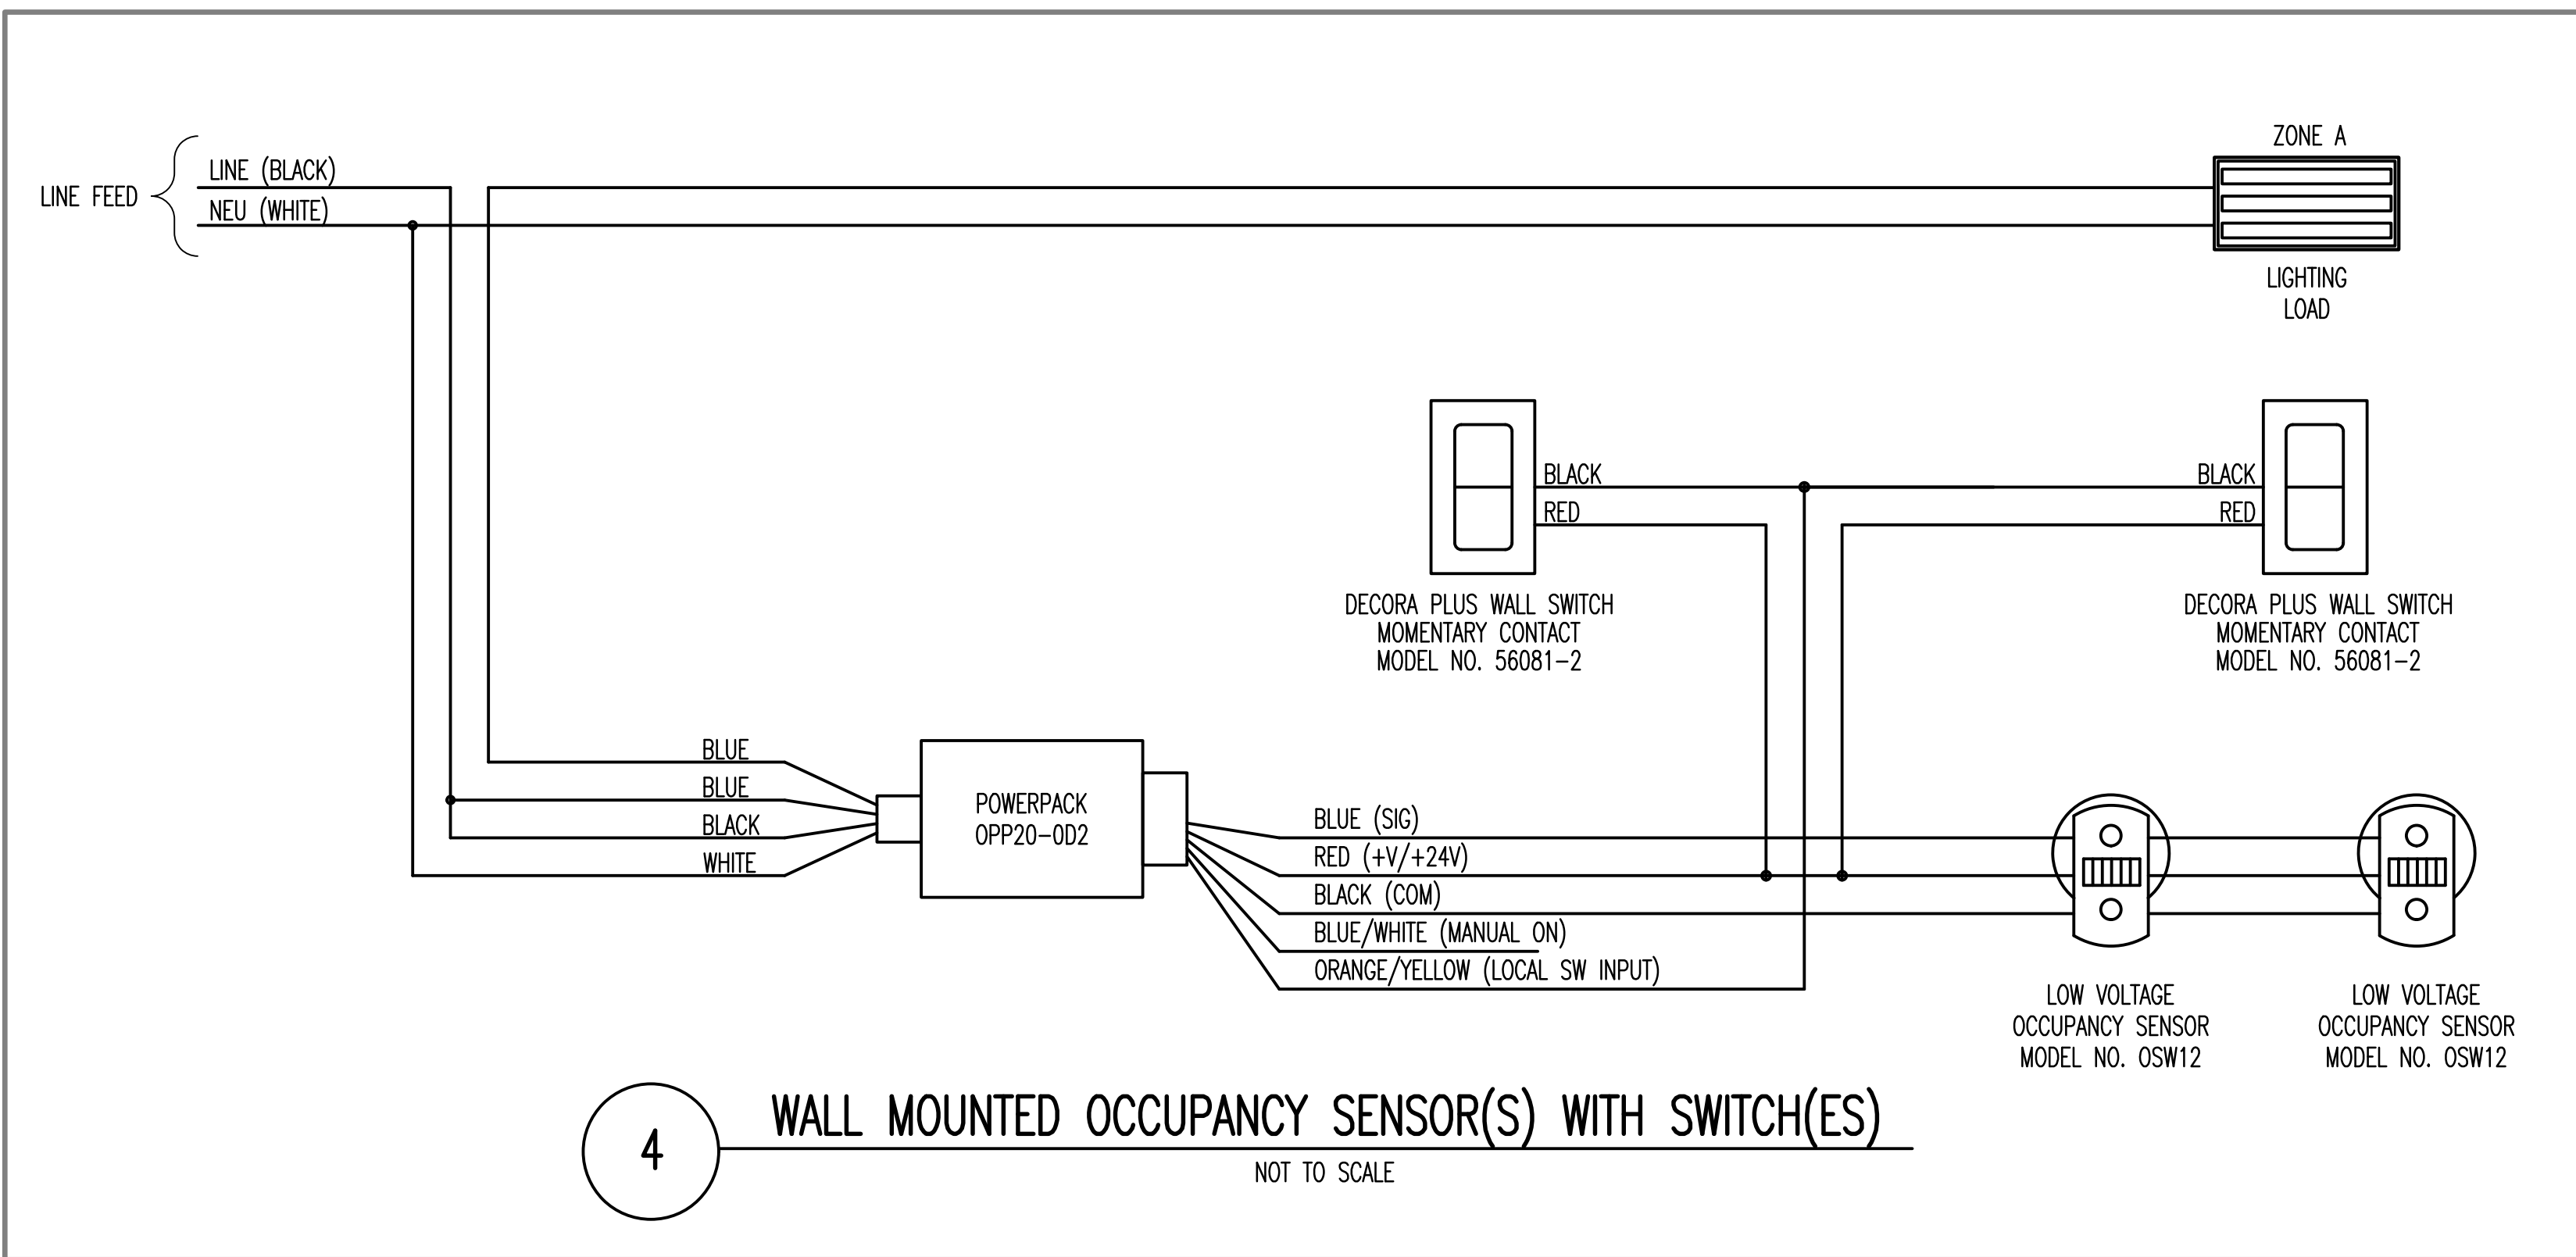
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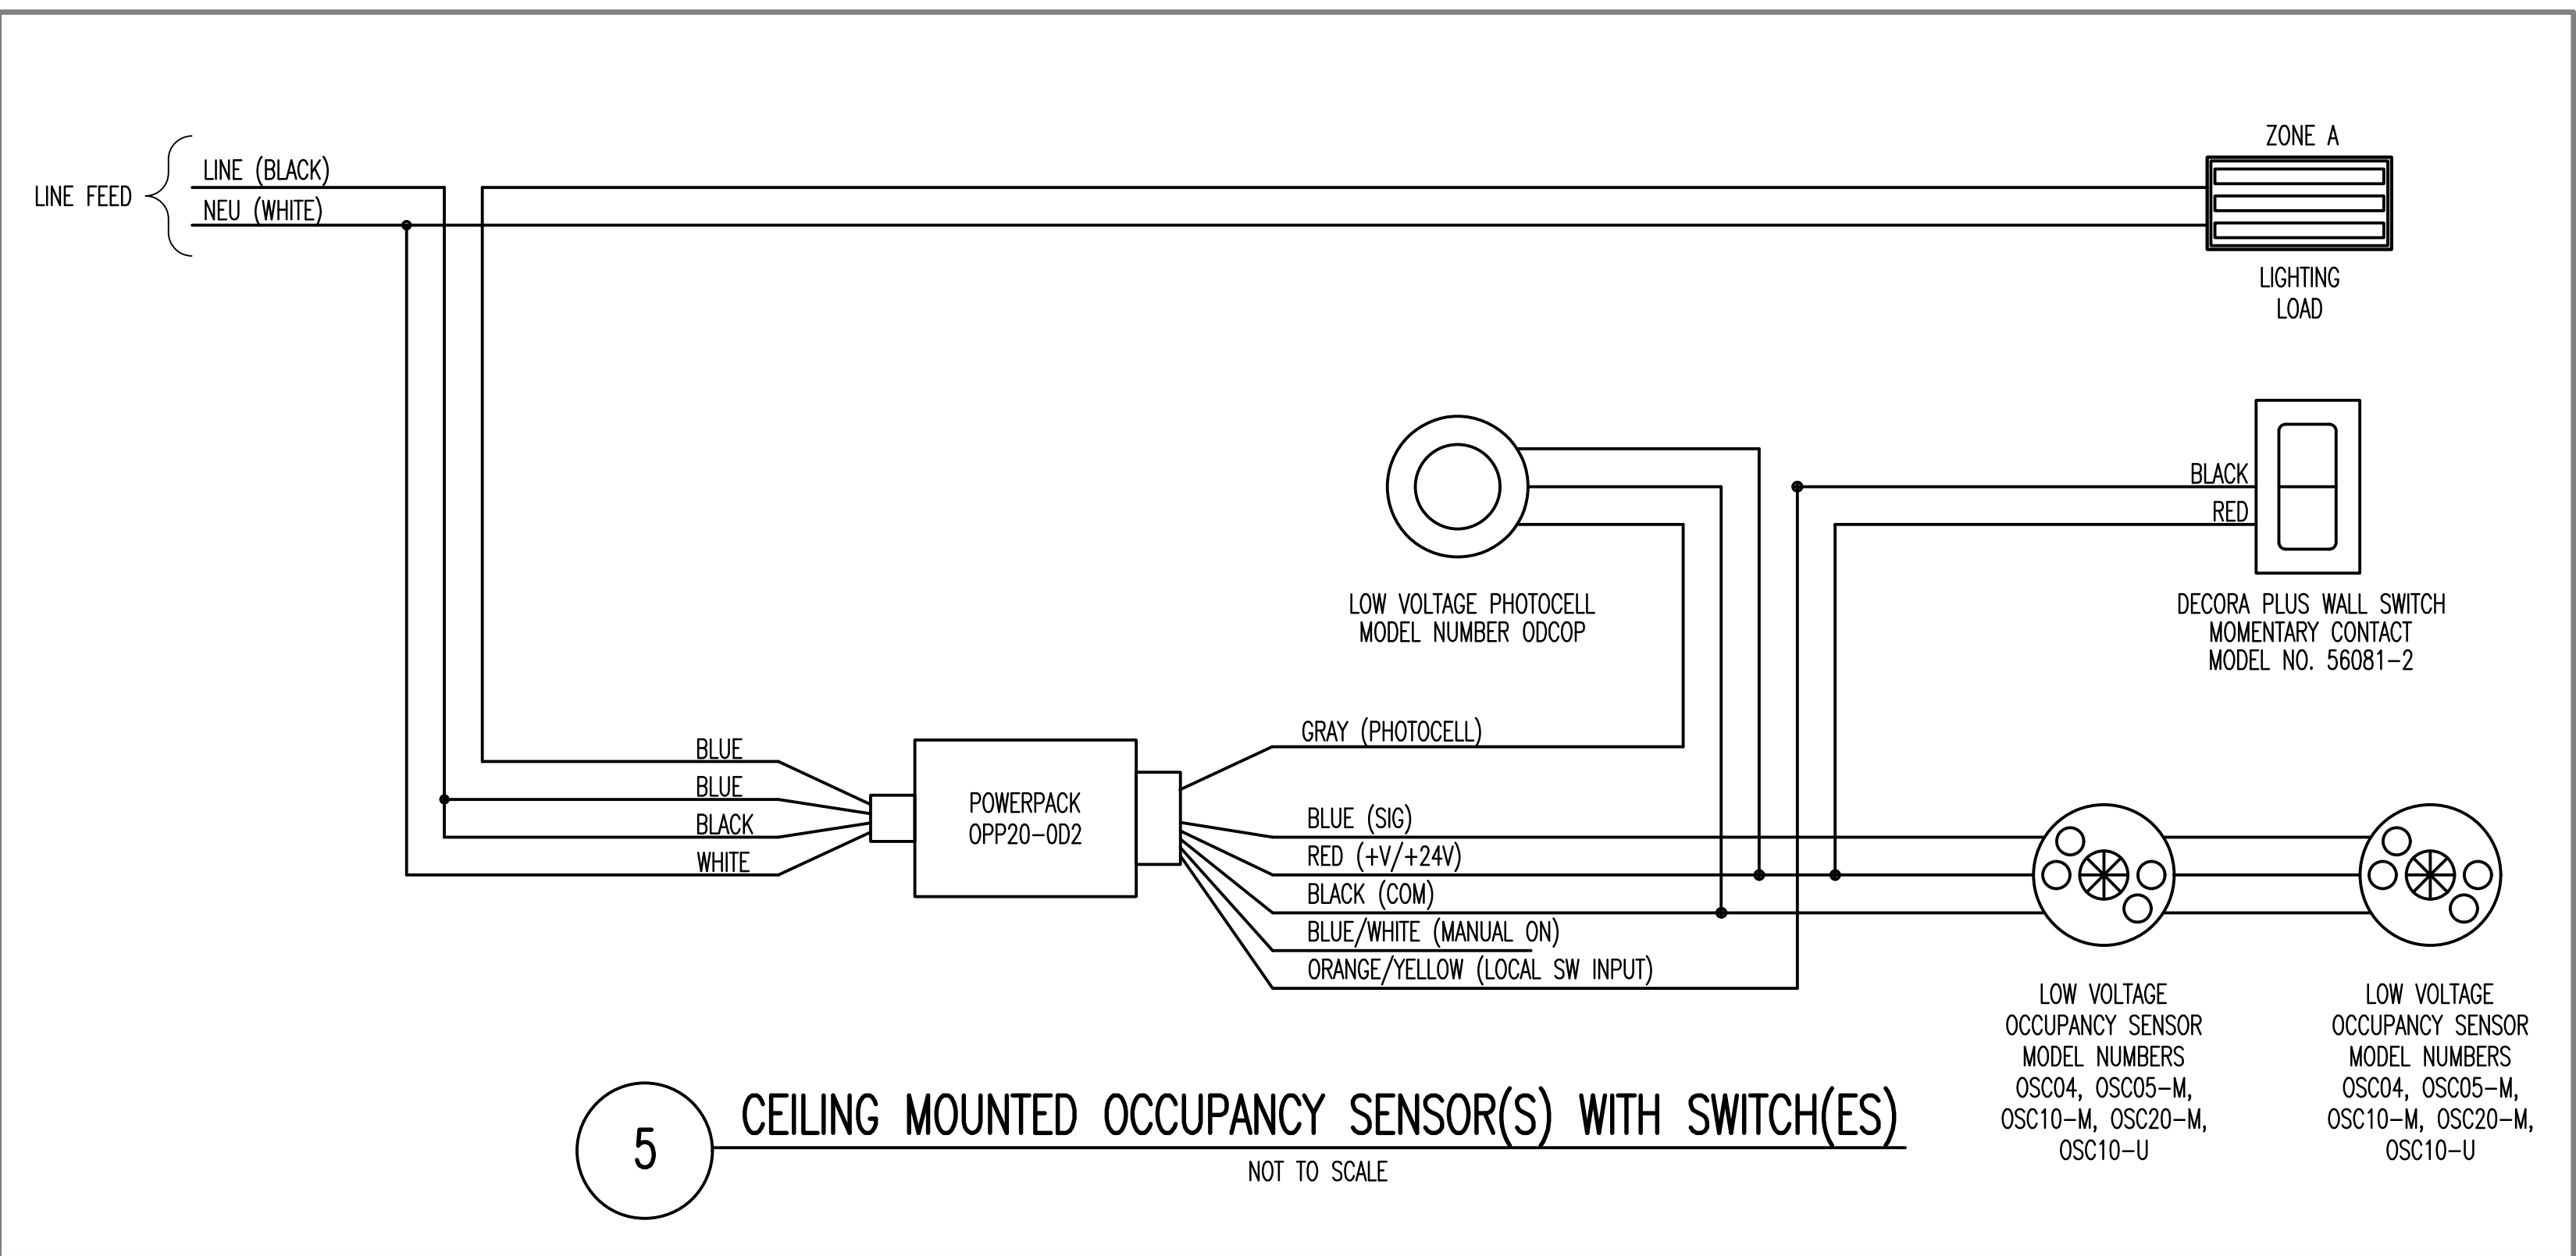
ROOMS 5A,5B,5C,5D,54,55,157



ROOMS 4,5,7,8,50,51,53



ROOMS 30,34,36,153,156

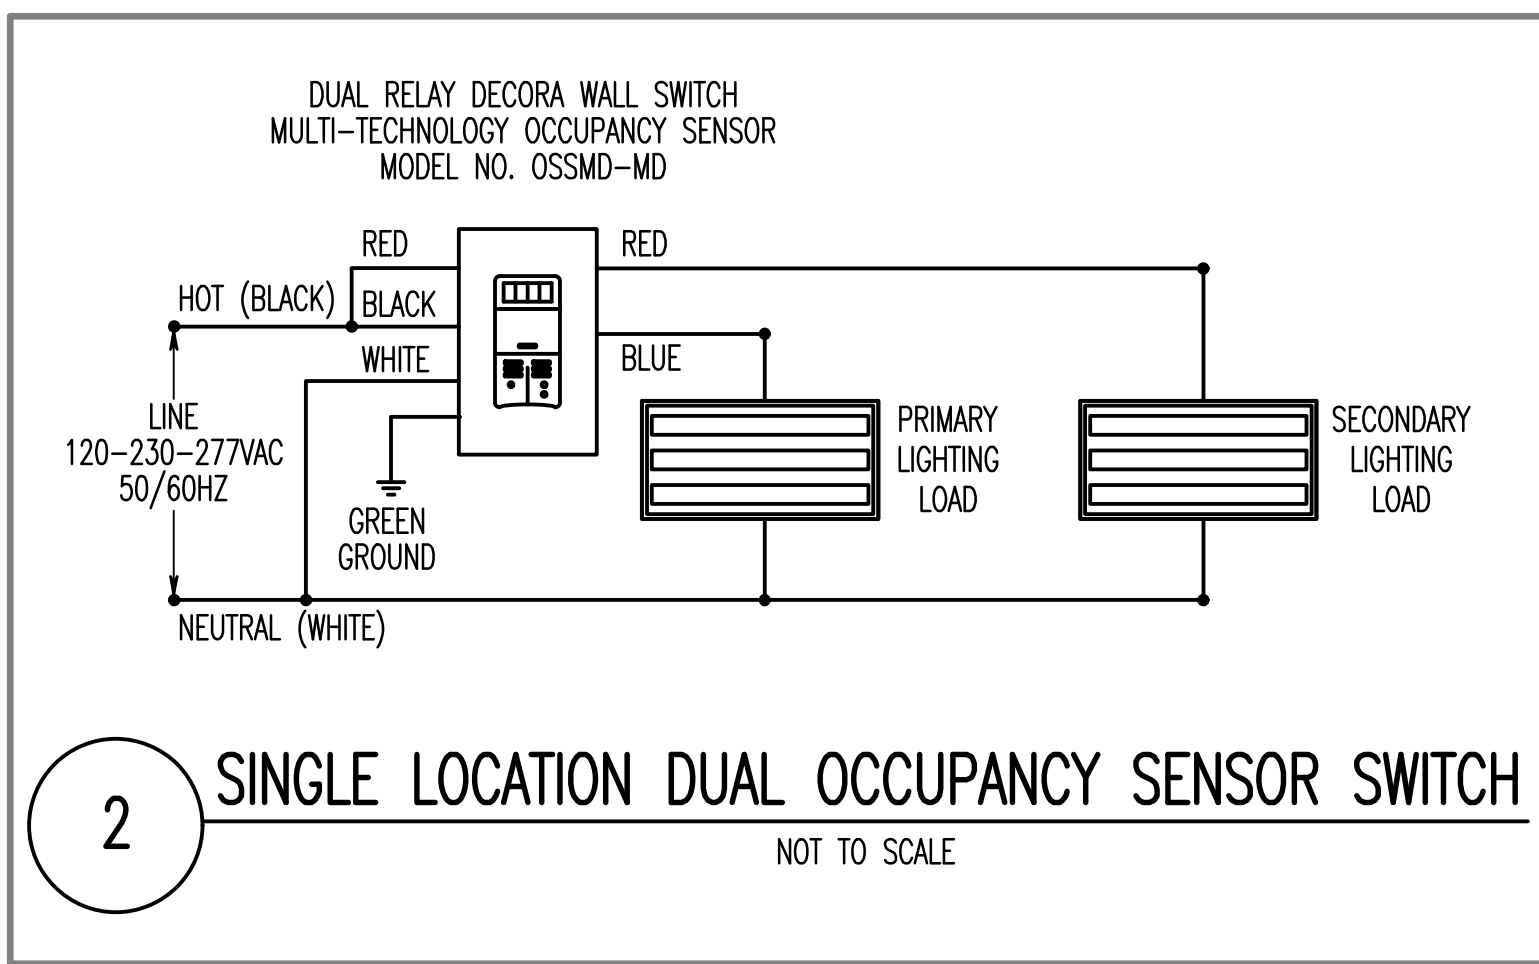

ROOM 6

TYPICAL SPACE TYPE	LINE VOLTAGE CONTROL DEVICES		LOW VOLTAGE CONTROL DEVICES		SWITCHING/DIMMING		MISCELLANEOUS		NOTES
	TOGGLE SWITCH(ES)	CEILING/WALL MOUNTED OCCUPANCY SENSOR	WALL BOX OCCUPANCY SENSOR(S) WITH SINGLE OUTPUT RELAY	WALL BOX OCCUPANCY SENSOR(S) WITH DUAL OUTPUT RELAYS	WALL BOX OCCUPANCY SENSOR(S) WITH DUAL OUTPUT RELAYS	WALL BOX OCCUPANCY SENSOR(S) WITH DUAL OUTPUT RELAYS	WALL BOX OCCUPANCY SENSOR(S) WITH DUAL OUTPUT RELAYS	WALL BOX OCCUPANCY SENSOR(S) WITH DUAL OUTPUT RELAYS	
WAREHOUSE AISLES	-	-	-	-	-	-	-	-	(2)(1)(5)(6)
LOADING DOCK 30,34,35,36	-	-	-	-	-	-	-	-	
STORAGE 153, 156	-	-	-	-	-	-	-	-	
CORRIDOR 12, 100	-	-	-	-	-	-	-	-	(4)(1)
LOBBY	-	-	-	-	-	-	-	-	(4)(1)
VESTIBULE	-	-	-	-	-	-	-	-	(4)(1)
PRIVATE OFFICES	-	-	-	-	-	-	-	-	
CLOSET 56, 52	-	-	-	-	-	-	-	-	
WAREHOUSE OFFICE 51, 53	-	-	-	-	-	-	-	-	
TOILET 52, 155	-	-	-	-	-	-	-	-	
ELEC 152, 29, 33	X	-	-	-	-	-	-	-	
TRAINING 6	-	-	-	-	-	-	-	-	(5)
COPY ROOM 5	-	-	-	-	-	-	-	-	
BREAK ROOM 4	-	-	-	-	-	-	-	-	
PUBLIC RESTROOMS	-	-	-	-	-	-	-	-	
ELECTRICAL M2X	X	-	-	-	-	-	-	-	
MECHANICAL M1X	-	-	-	-	-	-	-	-	
MECHANICAL M3X	X	-	-	-	-	-	-	-	
MECHANICAL M4X	X	-	-	-	-	-	-	-	(1)
EXTERIOR	-	-	-	-	-	-	-	-	(3)
STAIRWELL	-	-	-	-	-	-	-	-	

DETAIL NOTES: (APPLY TO THIS DETAIL ONLY)

D.1 THE NETWORKED LIGHTING CONTROL SYSTEM SHALL HAVE A FIRE ALARM INTERFACE DEVICE; UPON INITIATION OF THE FIRE ALARM SYSTEM, ALL LIGHTING CONNECTED TO THE NETWORKED LIGHTING CONTROL SYSTEM SHALL TURN TO "FULL-ON".

SPECIAL NOTES: (APPLY TO THIS DETAIL ONLY)


- COORDINATE ON-OFF TIMES WITH VA COTR.
- TIME CLOCK SHALL CONTROL LIGHTS ON TO 50%. UPON DETECTION OF OCCUPANCY IN AISLE, LIGHTS SHALL COME ON TO 100% IN THAT AISLE ONLY.
- TIME CLOCK SHALL CONTROL LIGHTS ON TO 50%. UPON DETECTION OF OCCUPANCY IN STAIRWELL, BY OCCUPANCY SENSOR INTEGRAL TO LIGHTING FIXTURE, ALL LIGHTING FIXTURES IN STAIRWELL SHALL COME ON TO 100%.
- TIME CLOCK SHALL CONTROL LIGHTS ON TO 50%. UPON DETECTION OF OCCUPANCY, LIGHTS SHALL COME ON TO 100%.
- DAYLIGHT DIMMING SHALL CONTROL LIGHTS TO MAINTAIN LEVEL AMOUNT OF LIGHT BY WINDOWS.
- WALL MOUNTED SWITCHES PROVIDE MANUAL OVERRIDE TO FULL OFF AND 50% ON.

6 LIGHTING CONTROL MATRIX

NOT TO SCALE

Additions:	Date
Revisions:	Date
SCHEMATIC DESIGN (30%) SUBMISSION	03/25/15
DESIGN DEVELOPMENT (60%) SUBMISSION	09/11/15
CONSTRUCTION DOCUMENTS (90% SUBMISSION)	11/23/15
BID DOCUMENTS	03/17/16

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Approved:

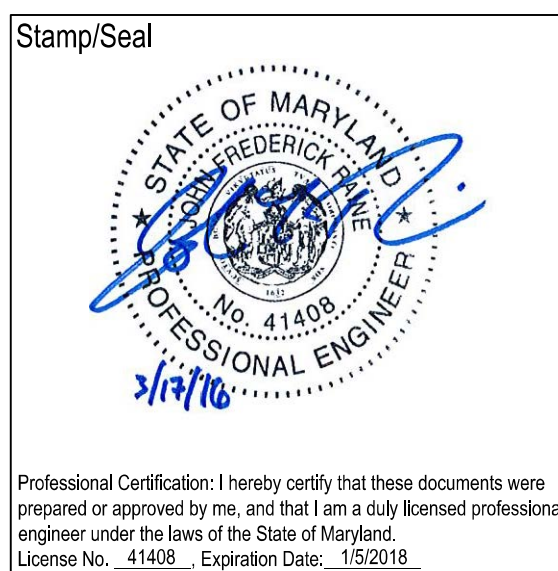Approved: Chief, Facilities and Engineering
Approved: Associate Chief for Maintenance And Operations, Perry Point
Approved: Engineering Projects Supervisor
Approved: Infection Control Officer

Drawing Title
LIGHTING CONTROL DETAILS
Approved: Associate Director for Operations
Approved: Director, Medical Center















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Project Title
WAREHOUSE RENOVATION & EXPANSION
Scale
NONE
Building Number
360
Checked
JFR
Drawn
MLS
Location
PERRY POINT, MD

Date
03/17/16
VA Project Number
512-530
Drawing Number
E500




THREE INCHES=ONE FOOT (3"=1'-0")
ONE AND ONE HALF INCHES=ONE FOOT (1 1/2"=1'-0")
ONE INCH=ONE FOOT (1"=1'-0")
THREE QUARTERS INCH=ONE FOOT (3/4"=1'-0")
ONE QUARTER INCH=ONE FOOT (1/4"=1'-0")
THREE EIGHTHS INCH=ONE FOOT (3/8"=1'-0")
ONE EIGHTH INCH=ONE FOOT (1/8"=1'-0")

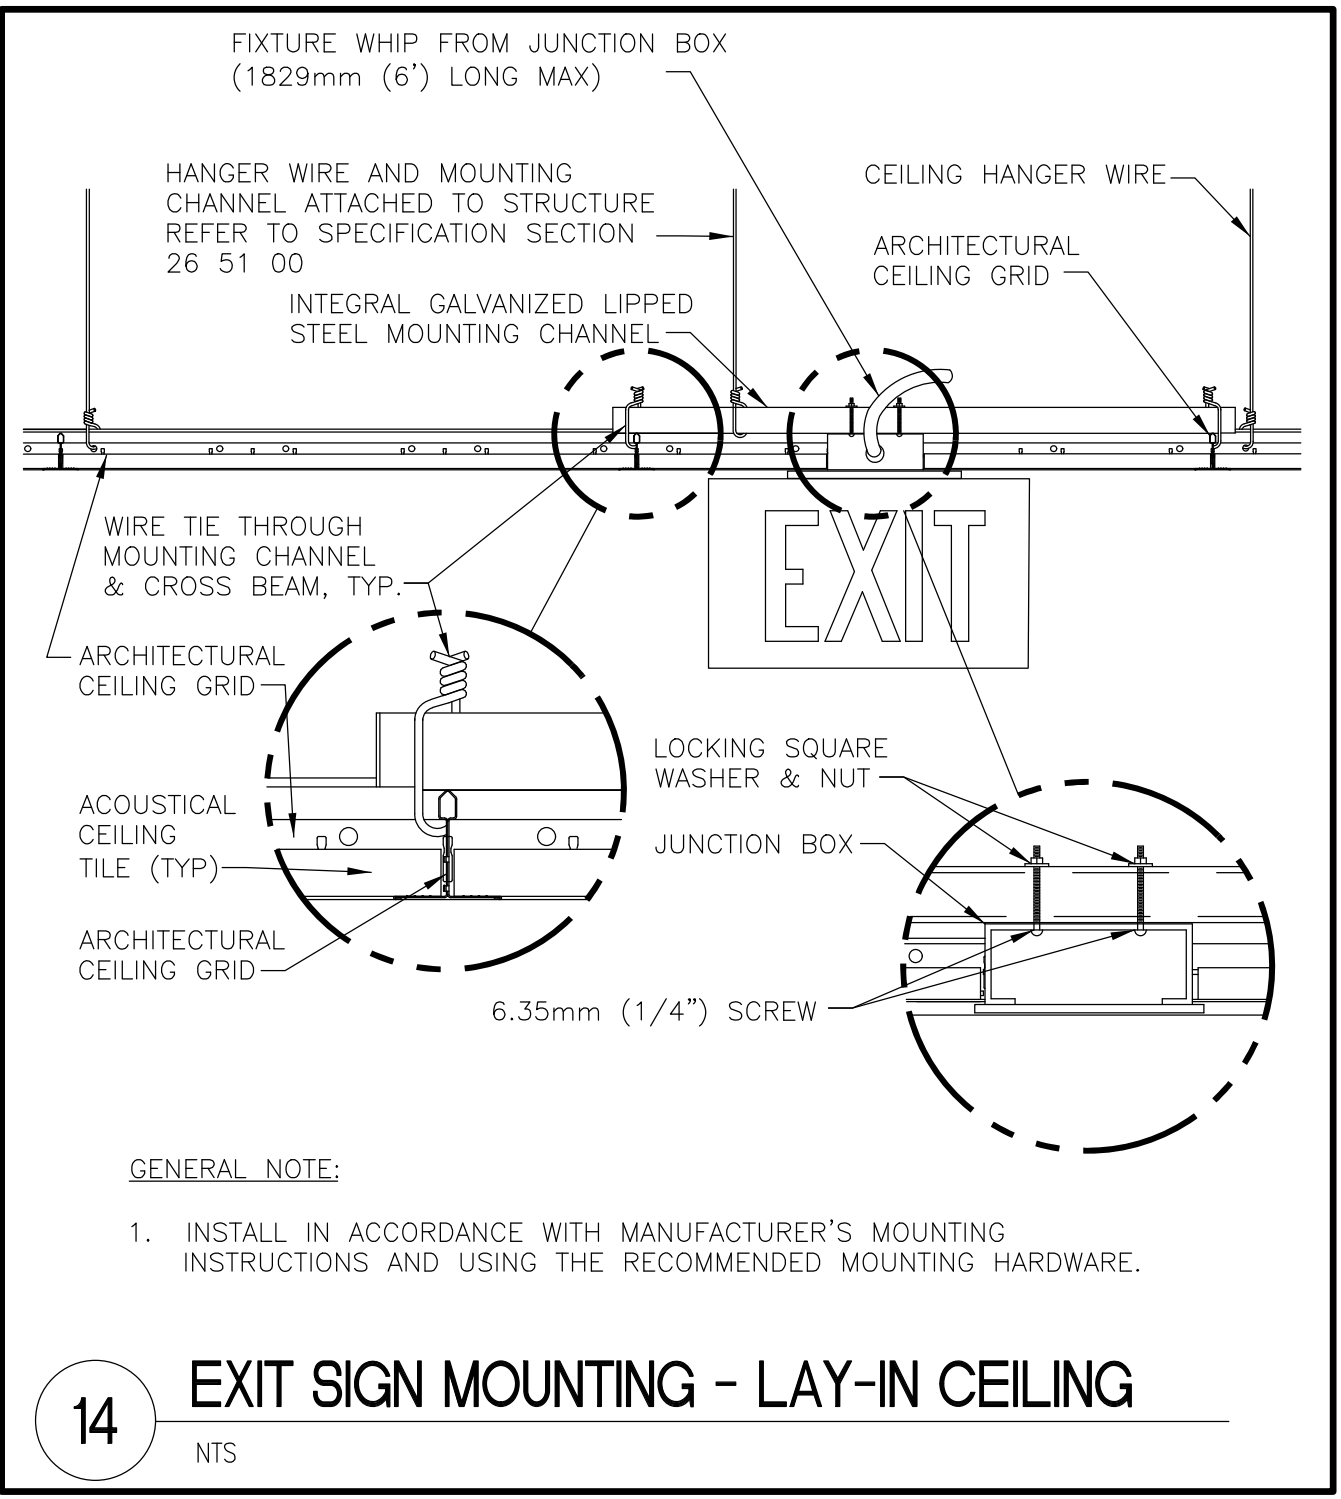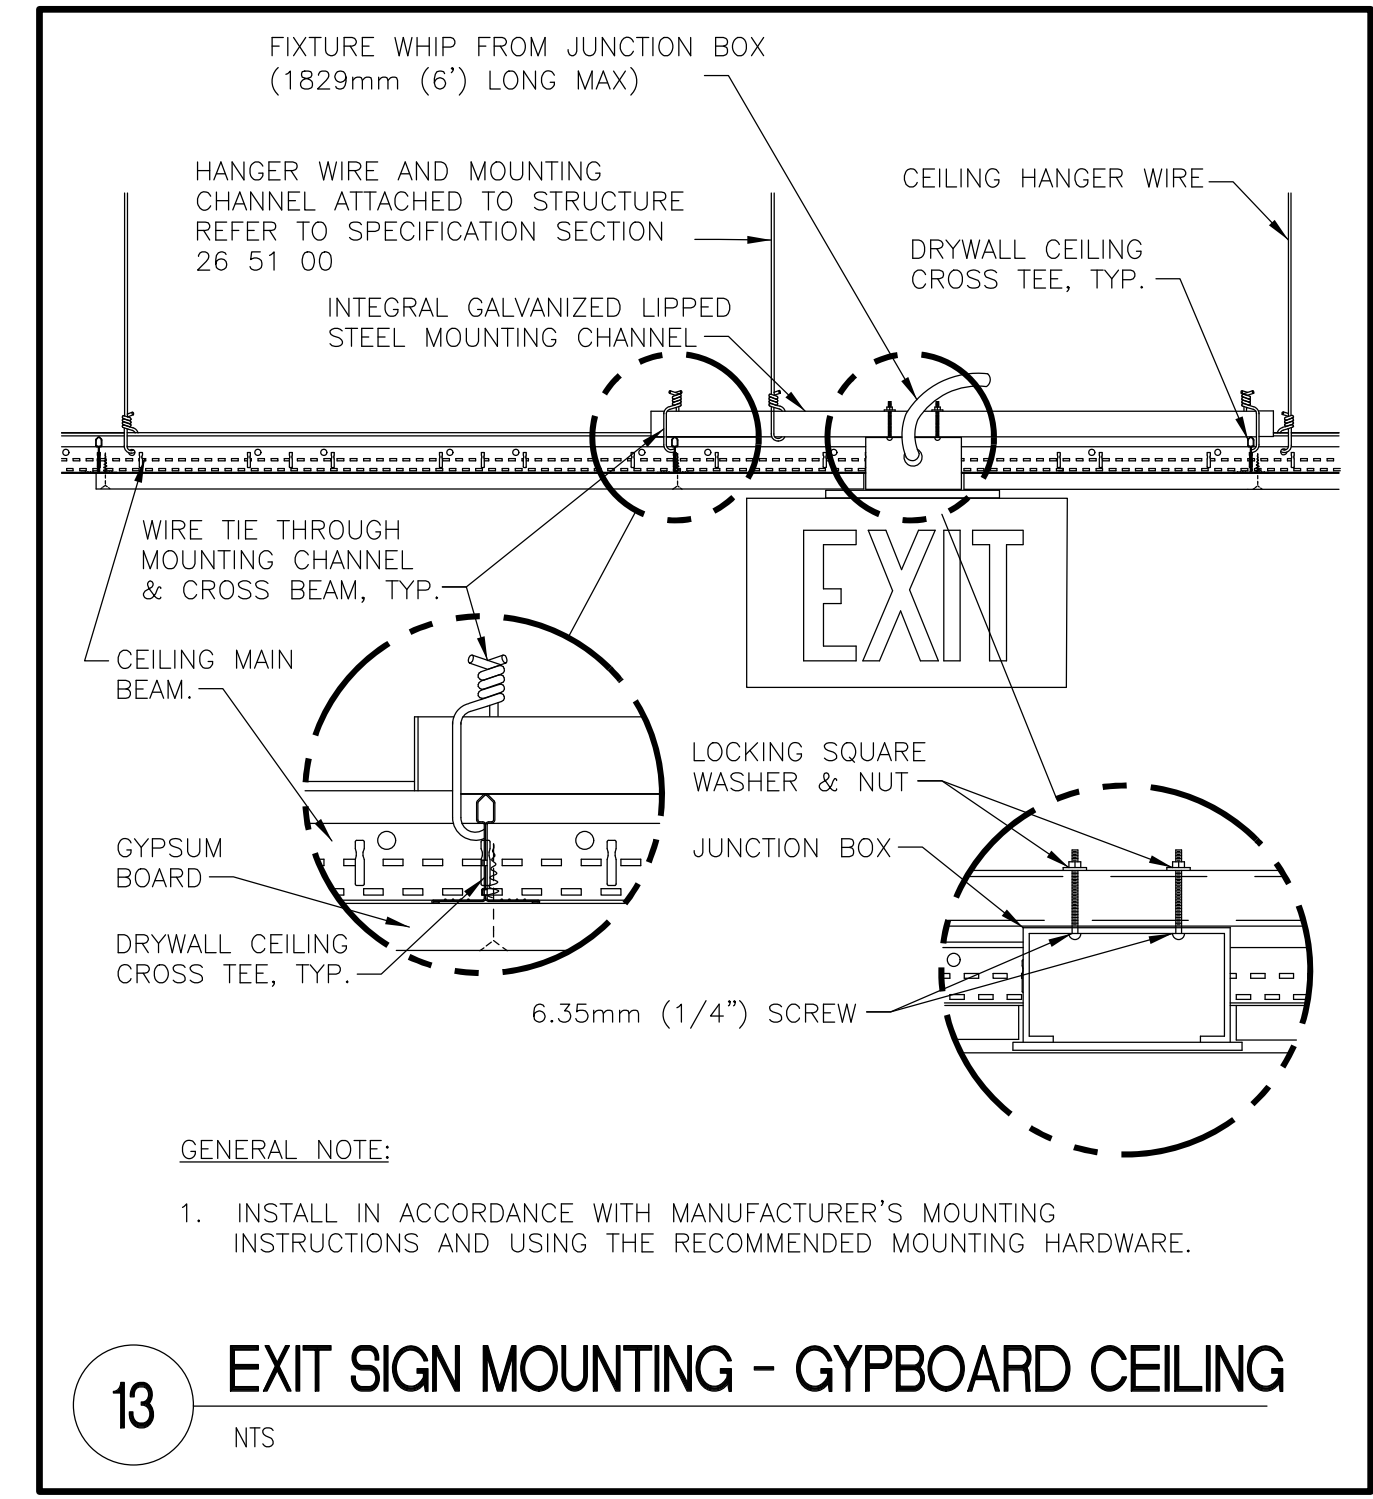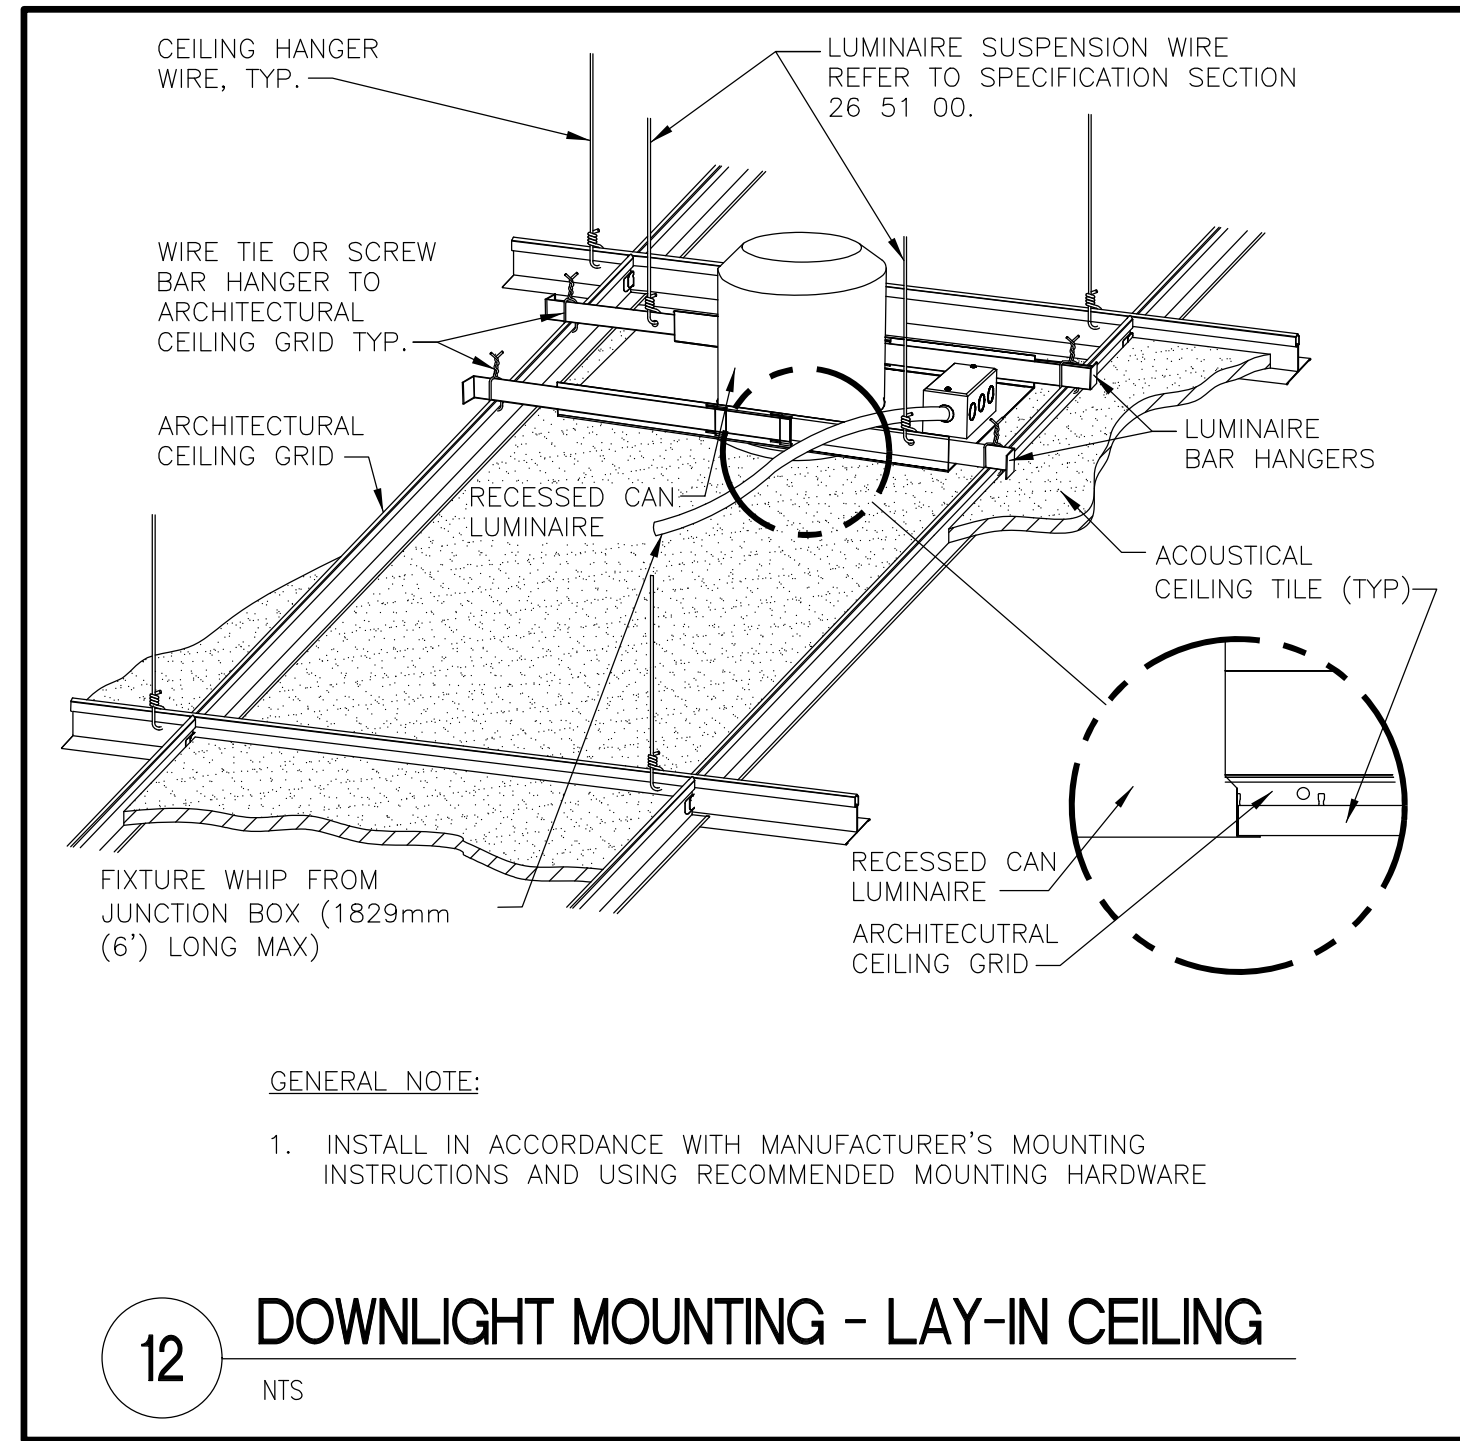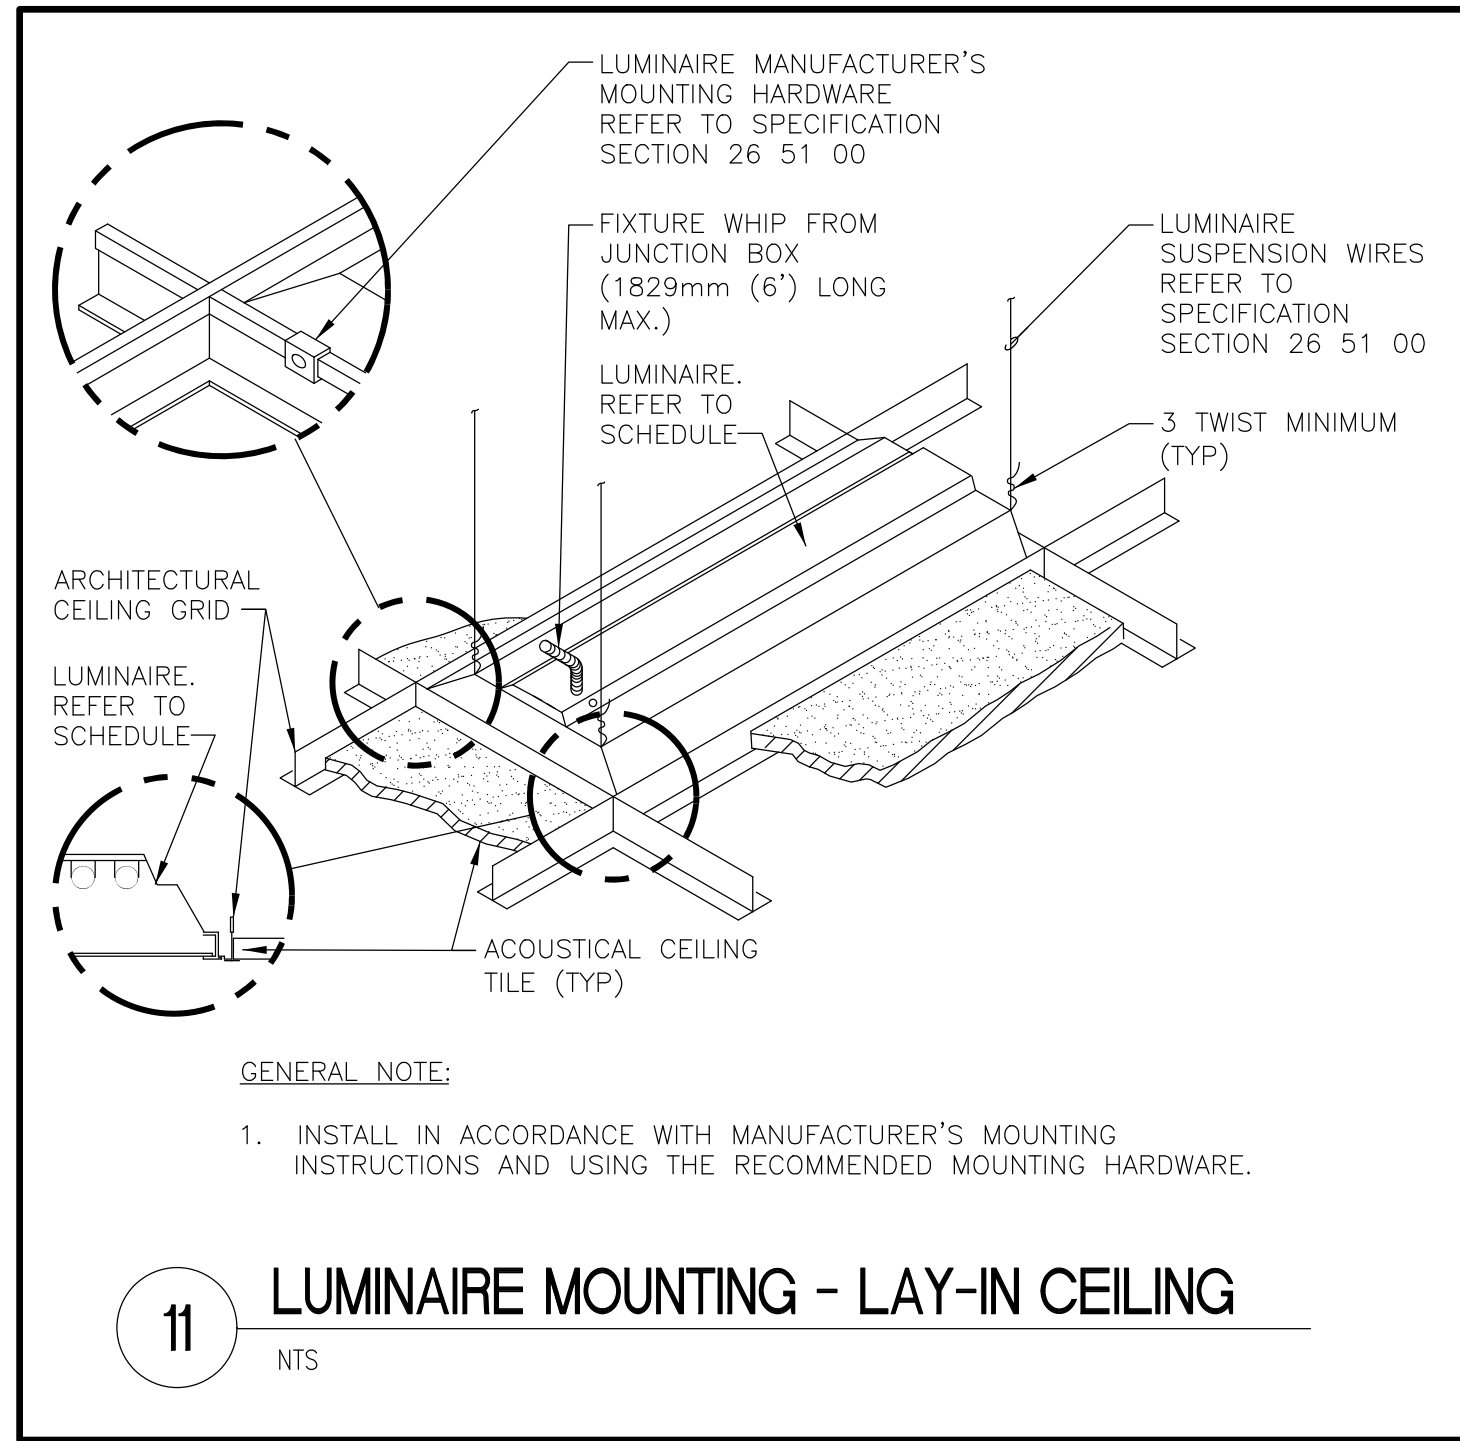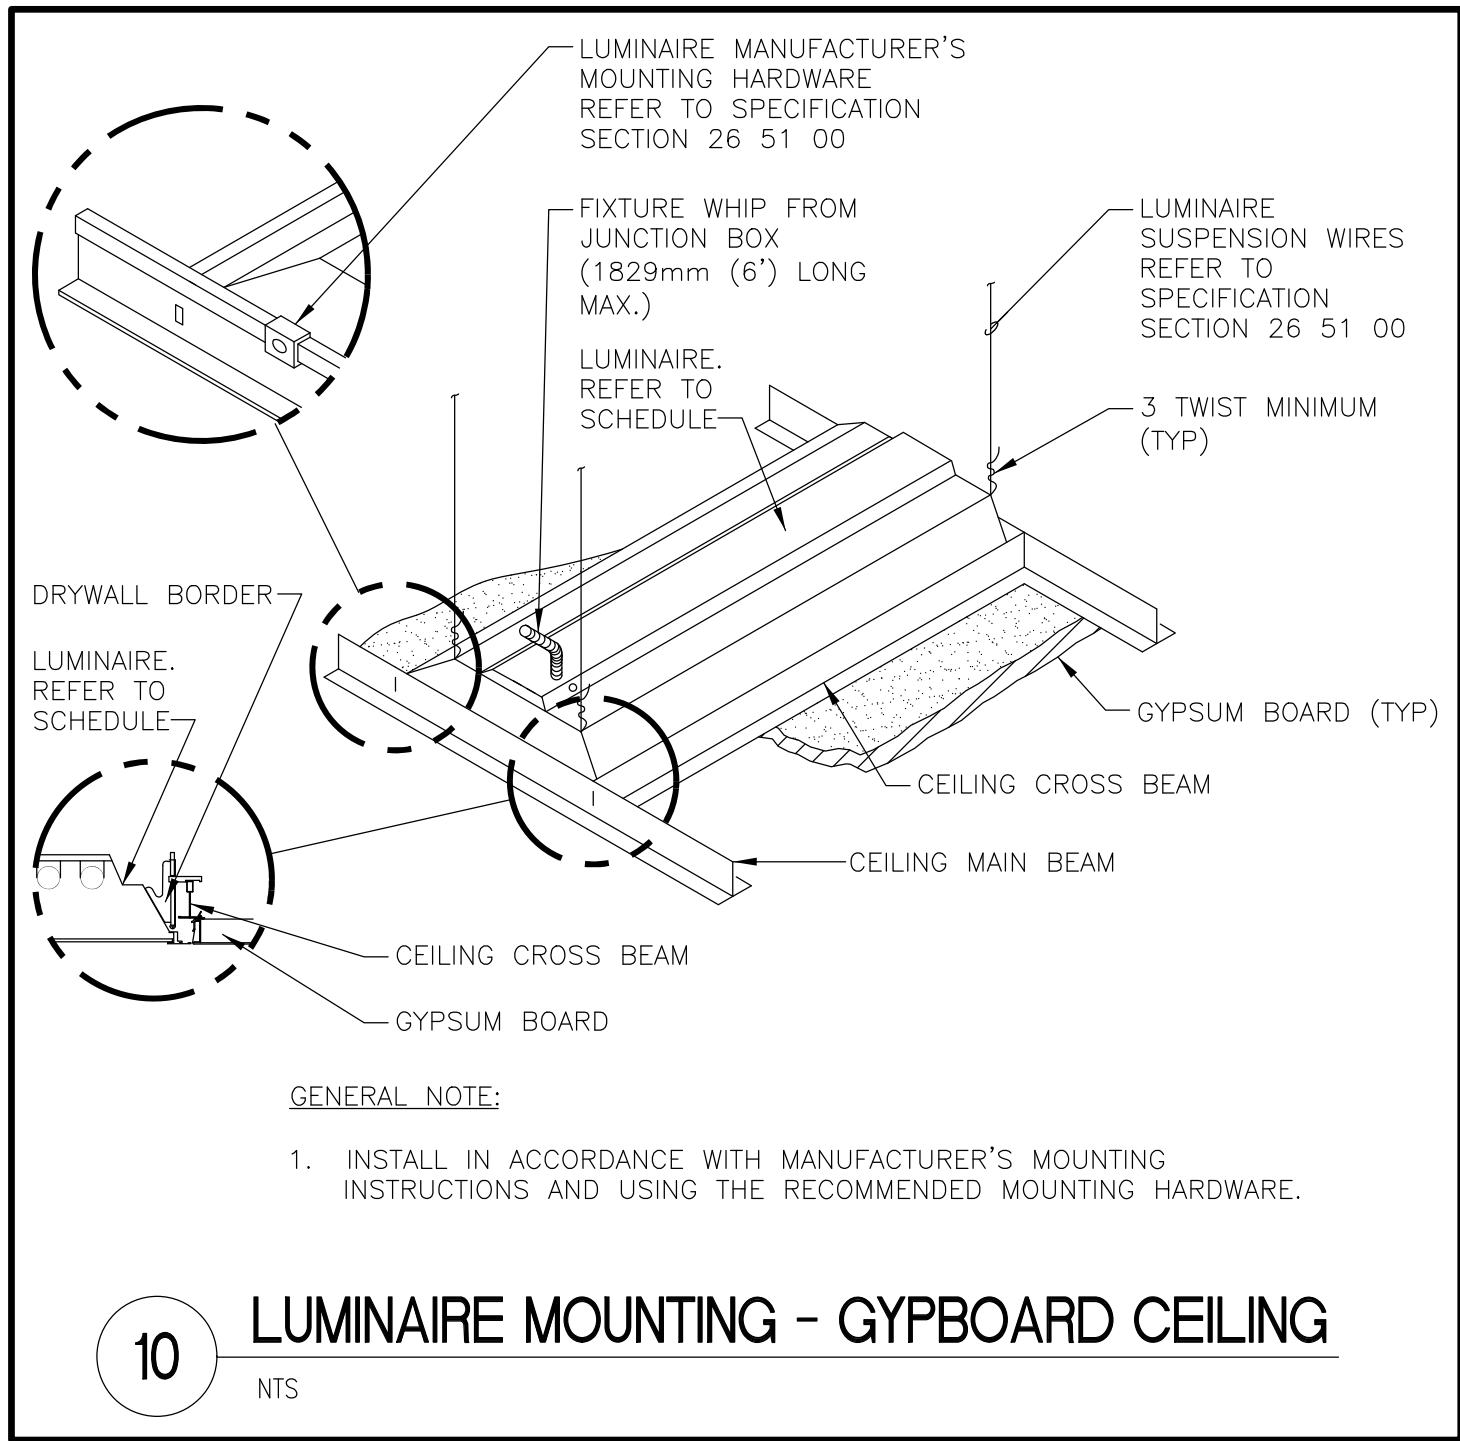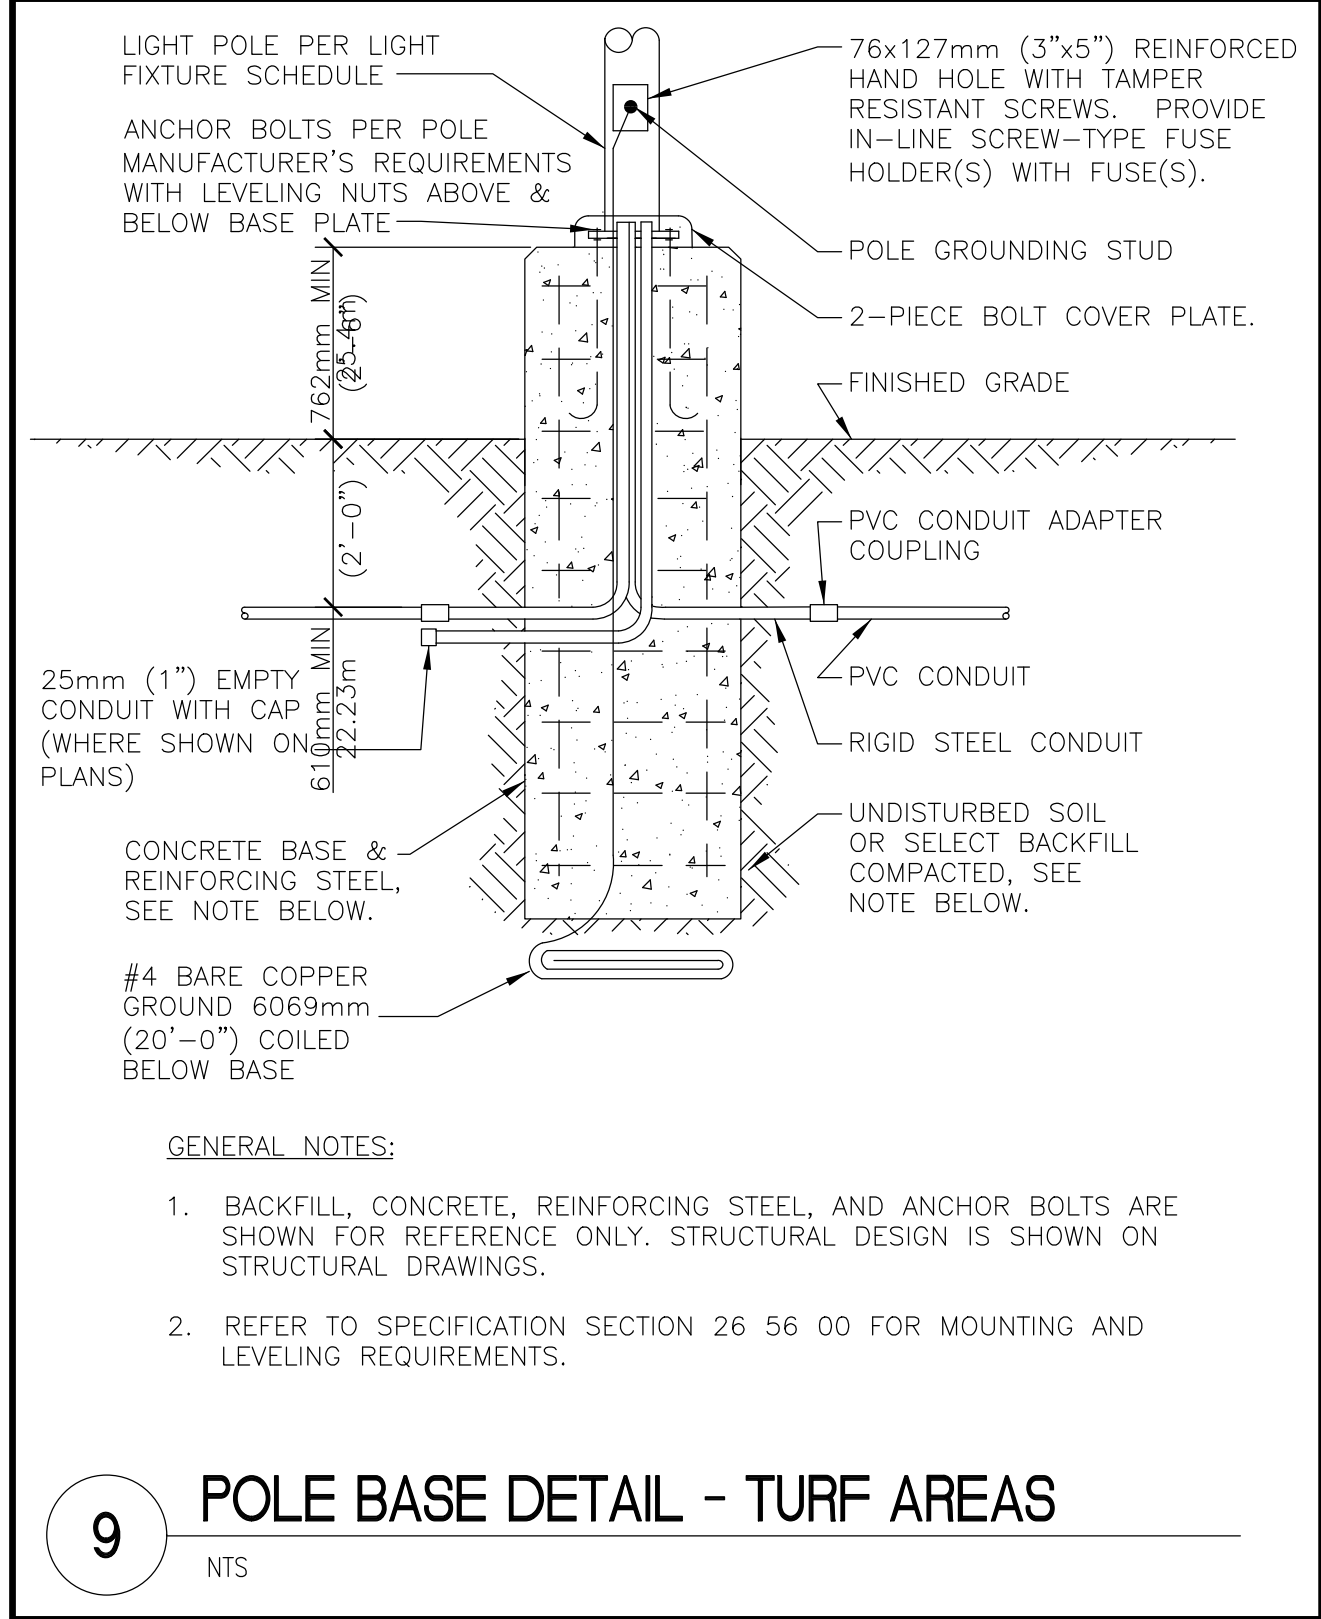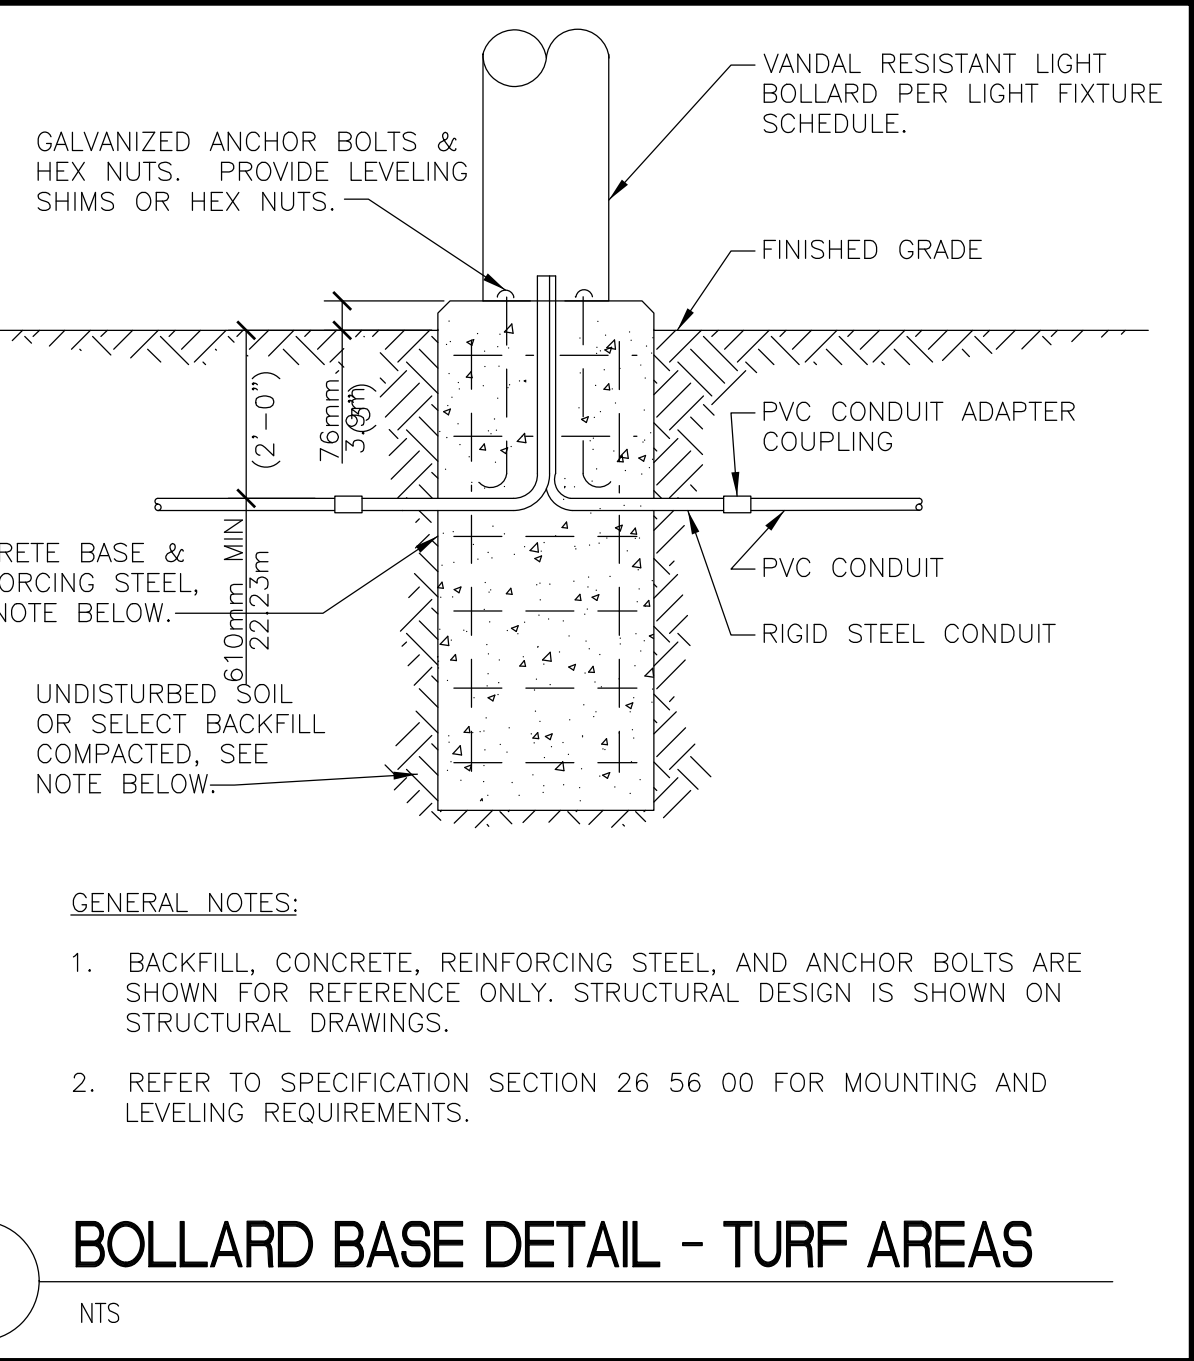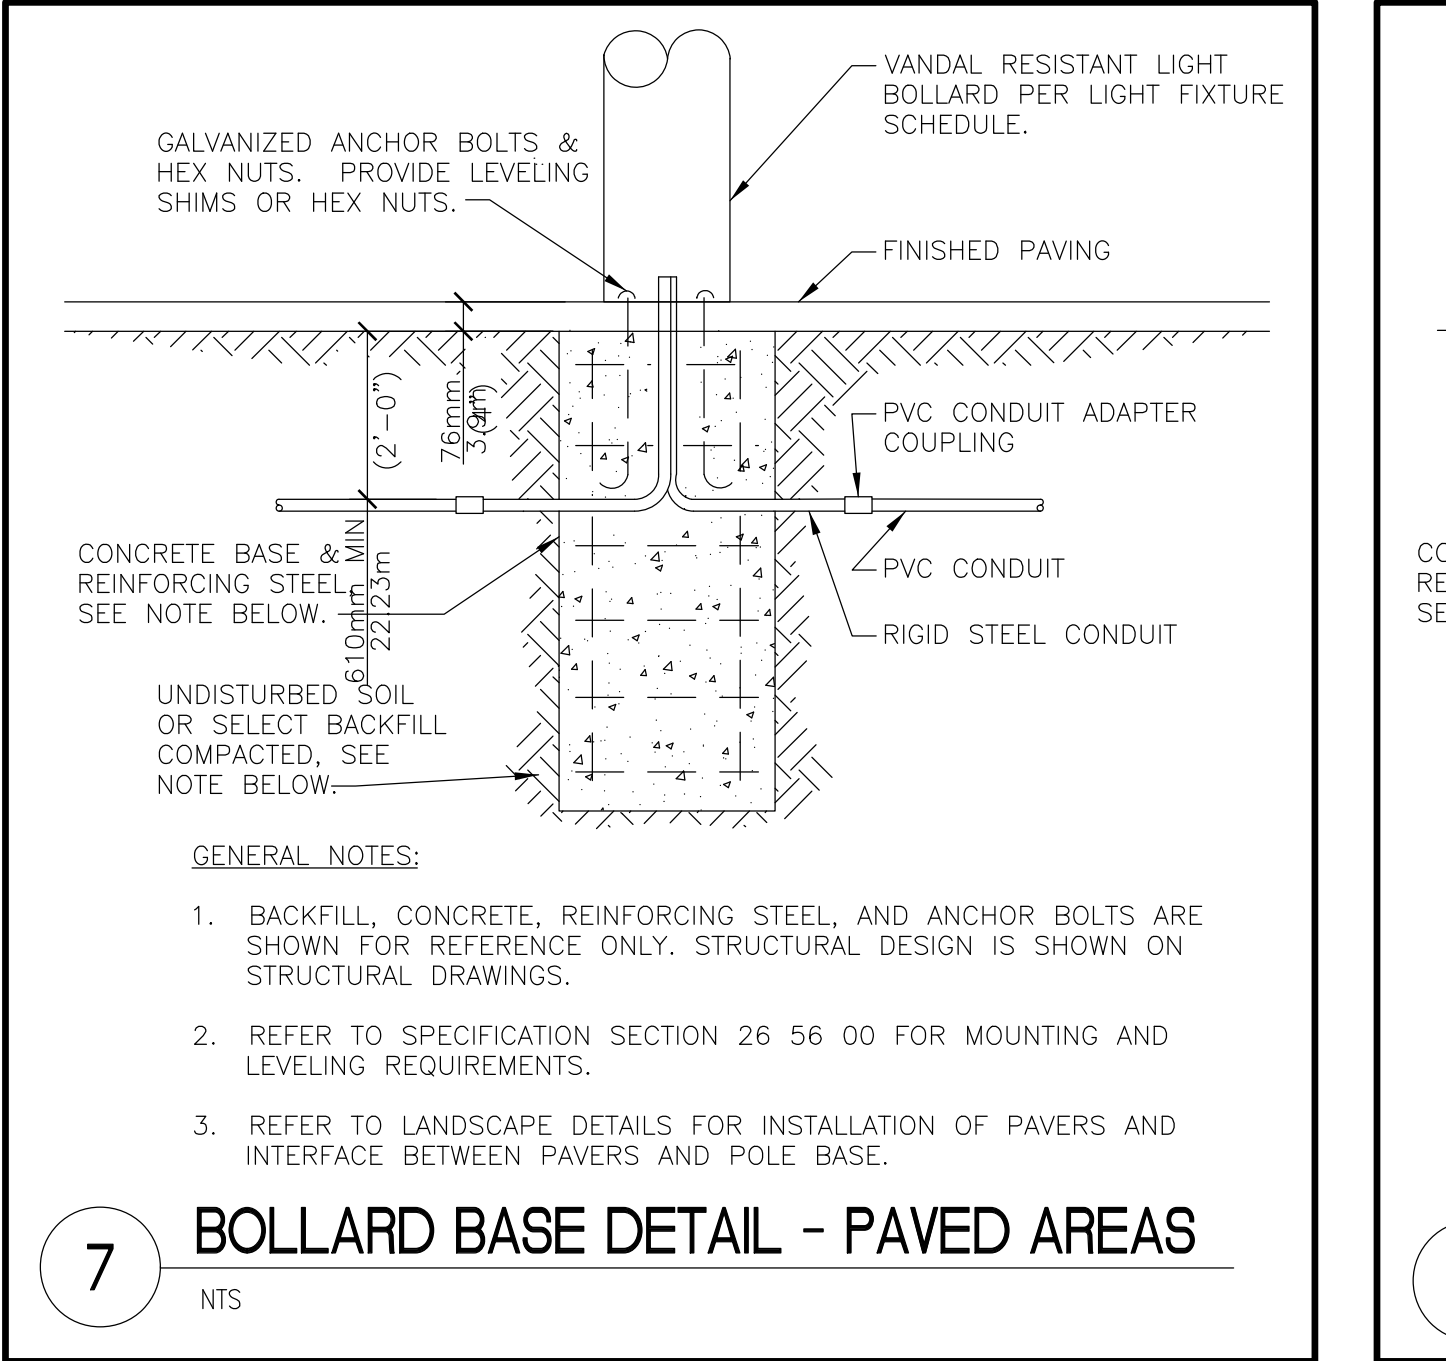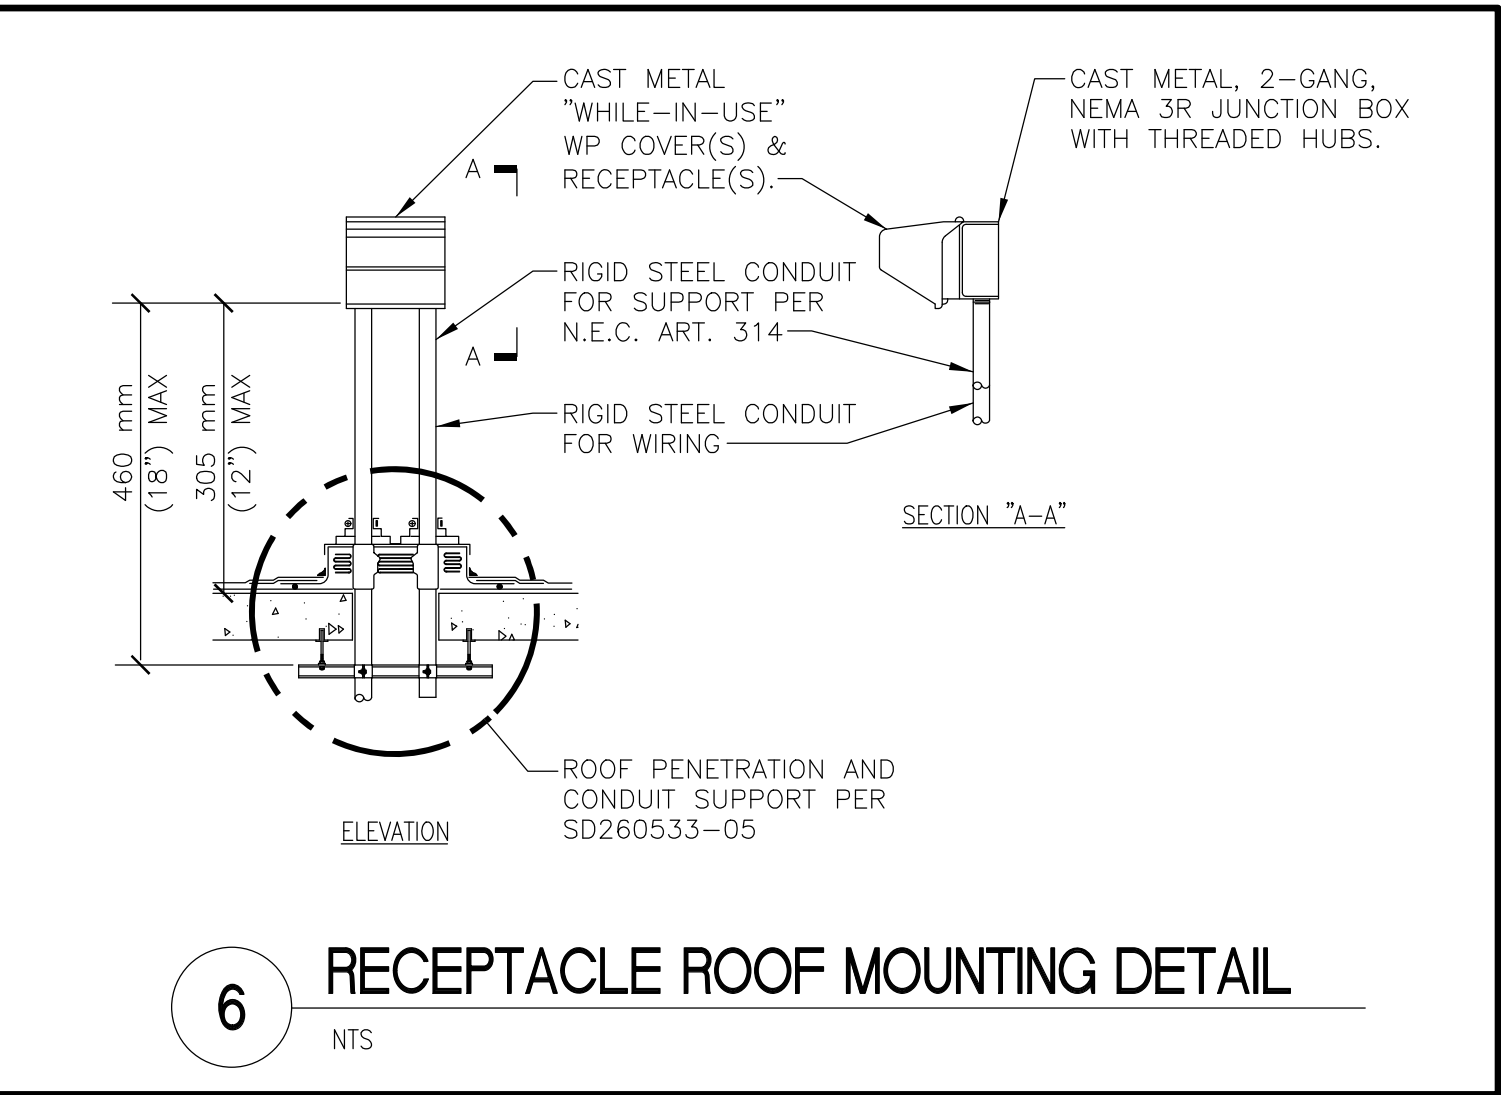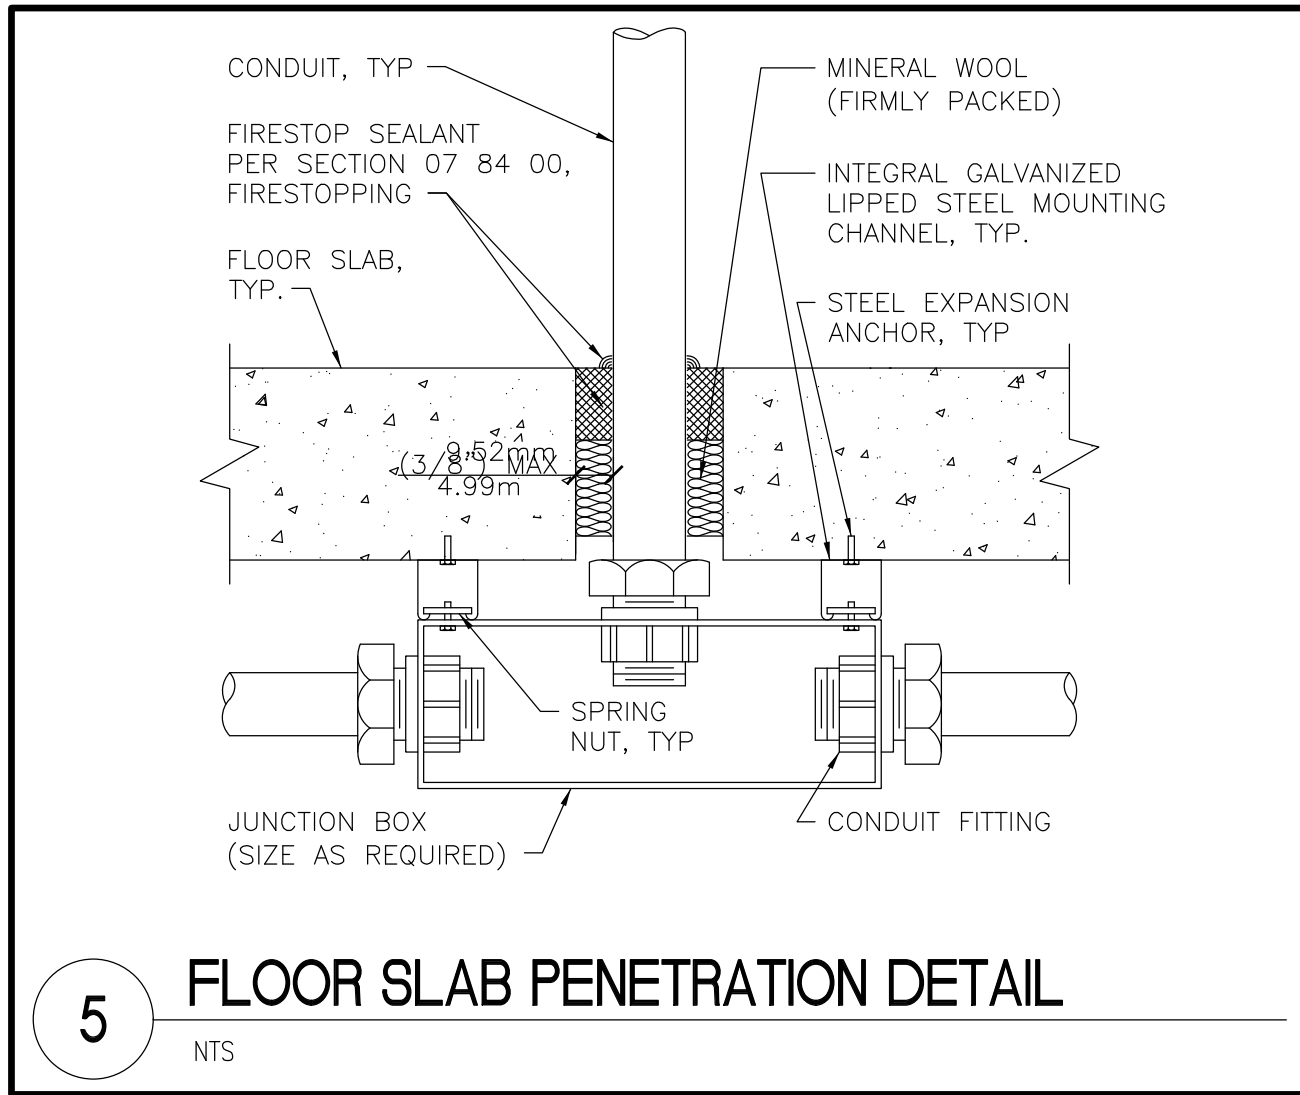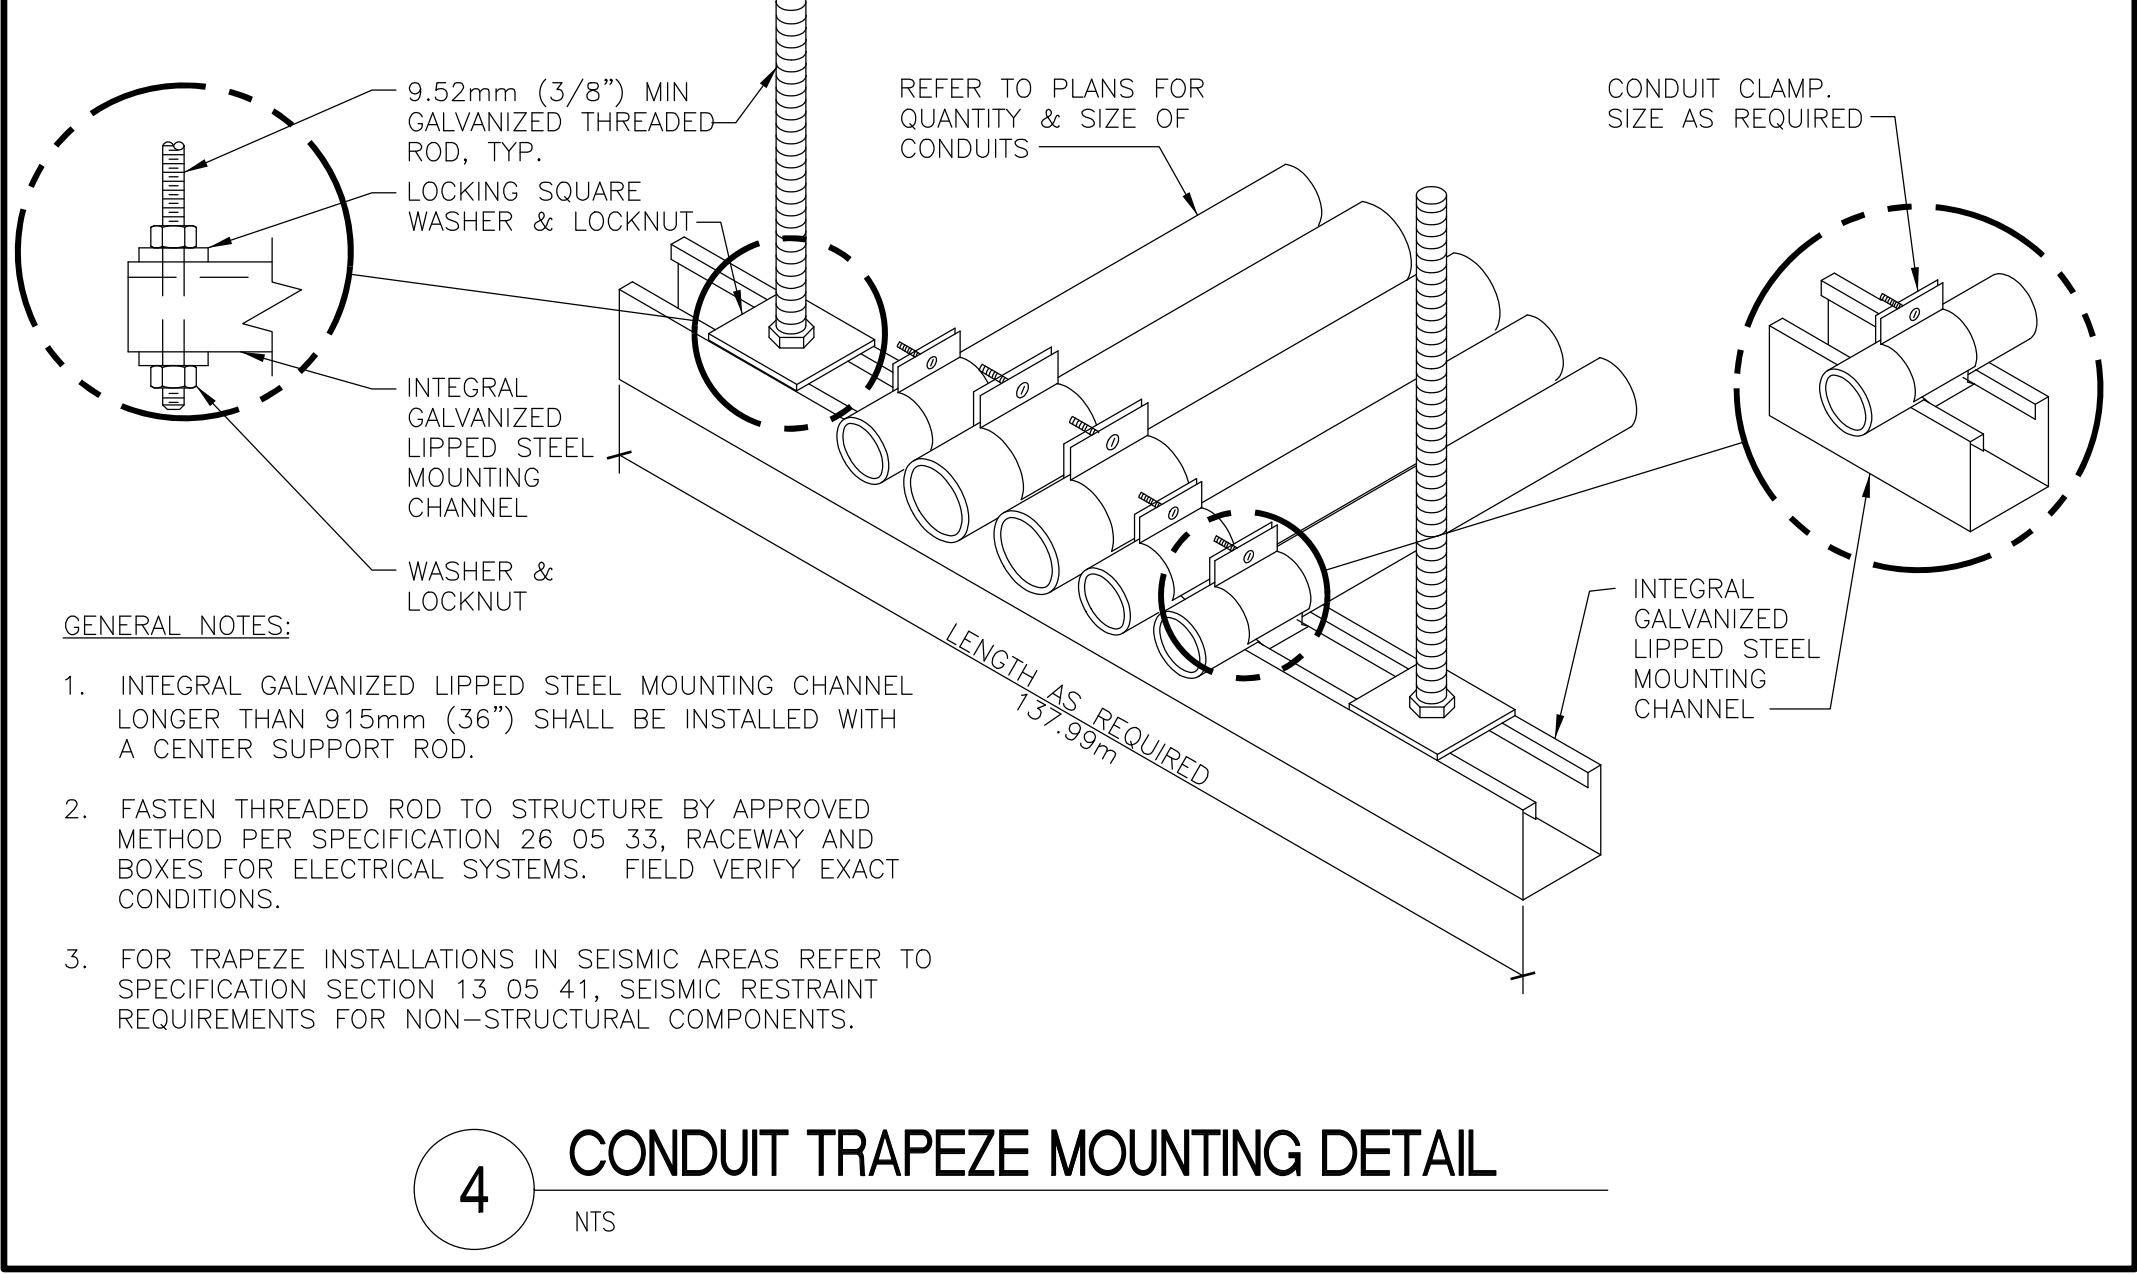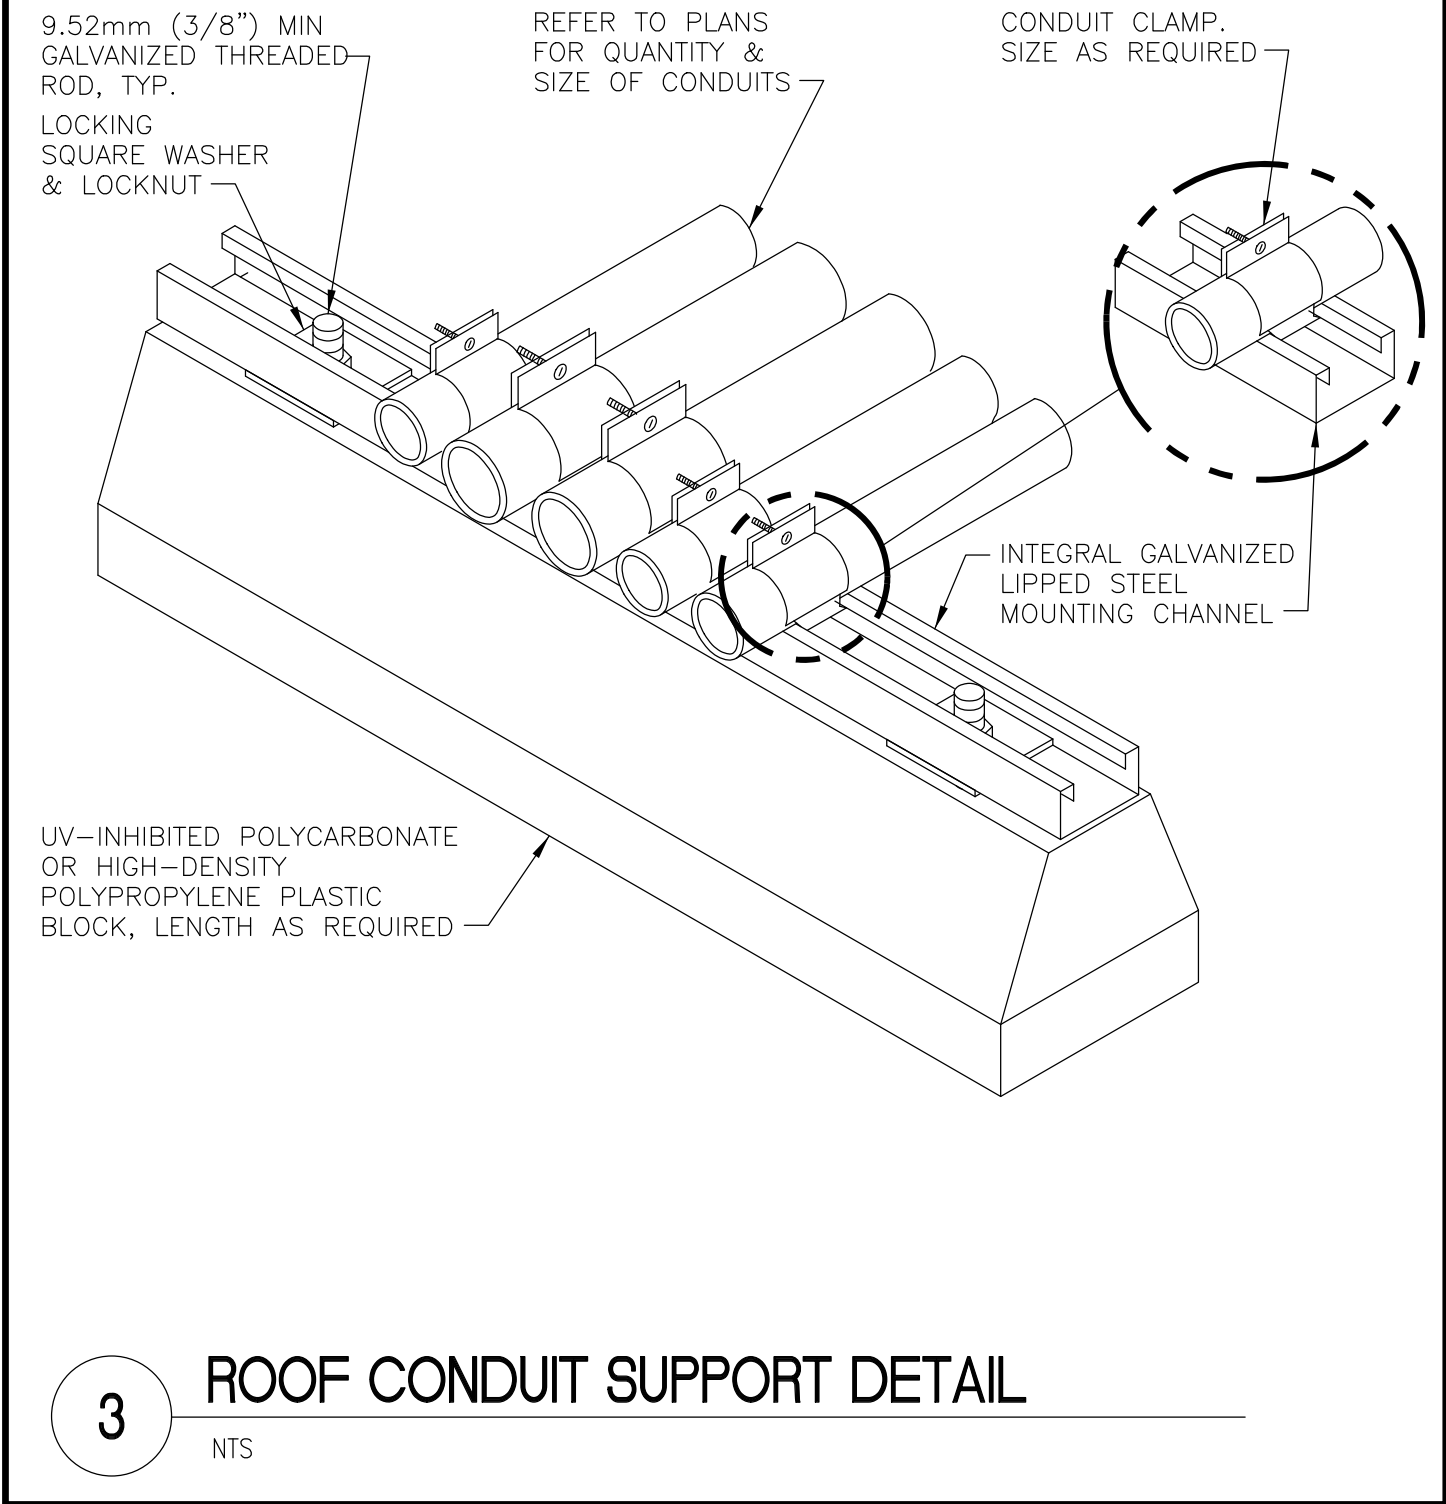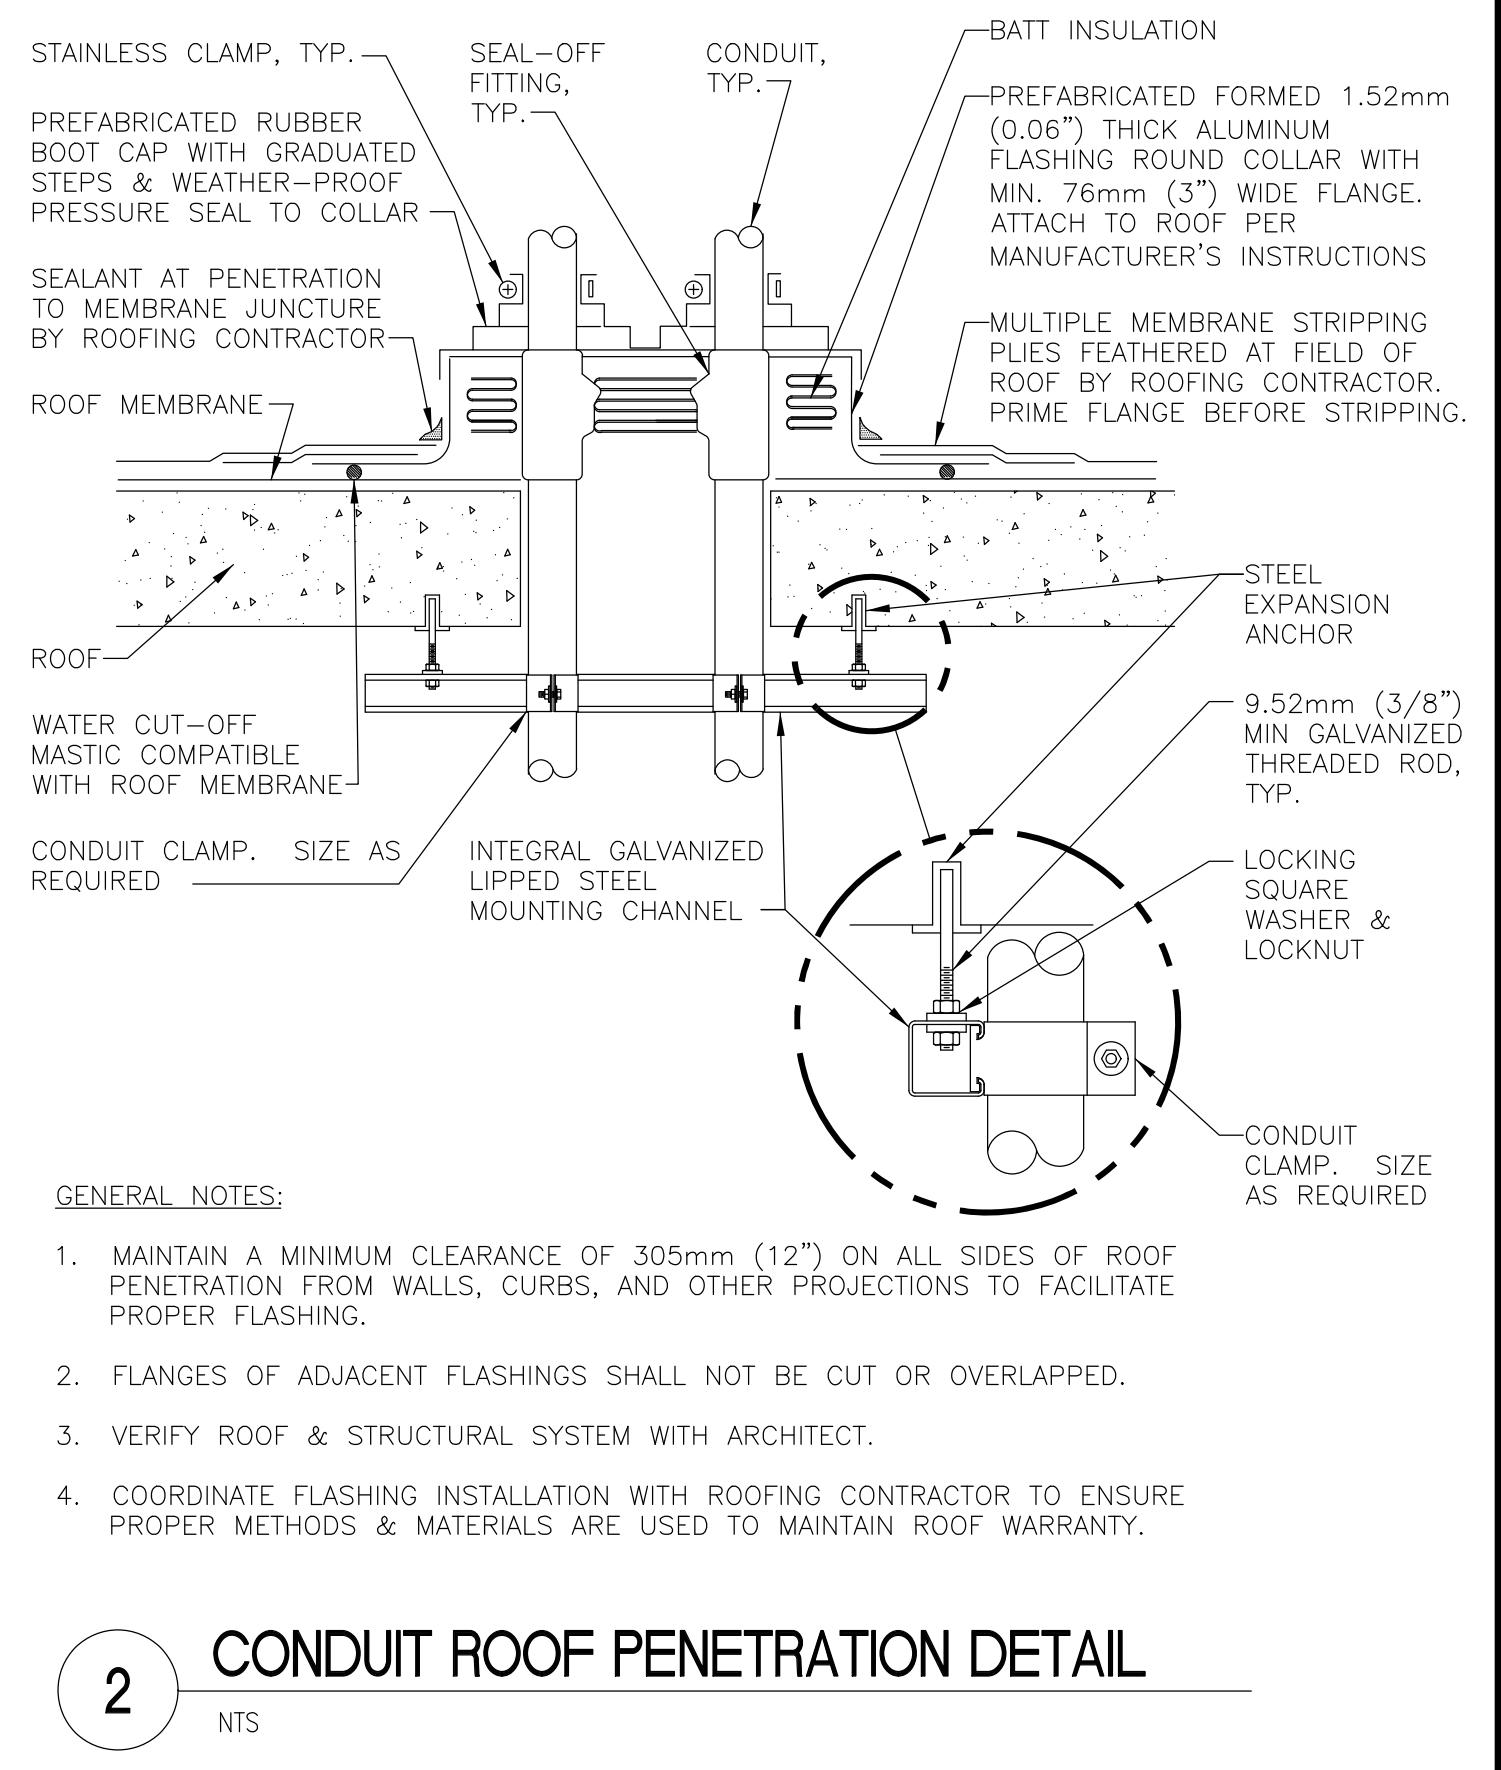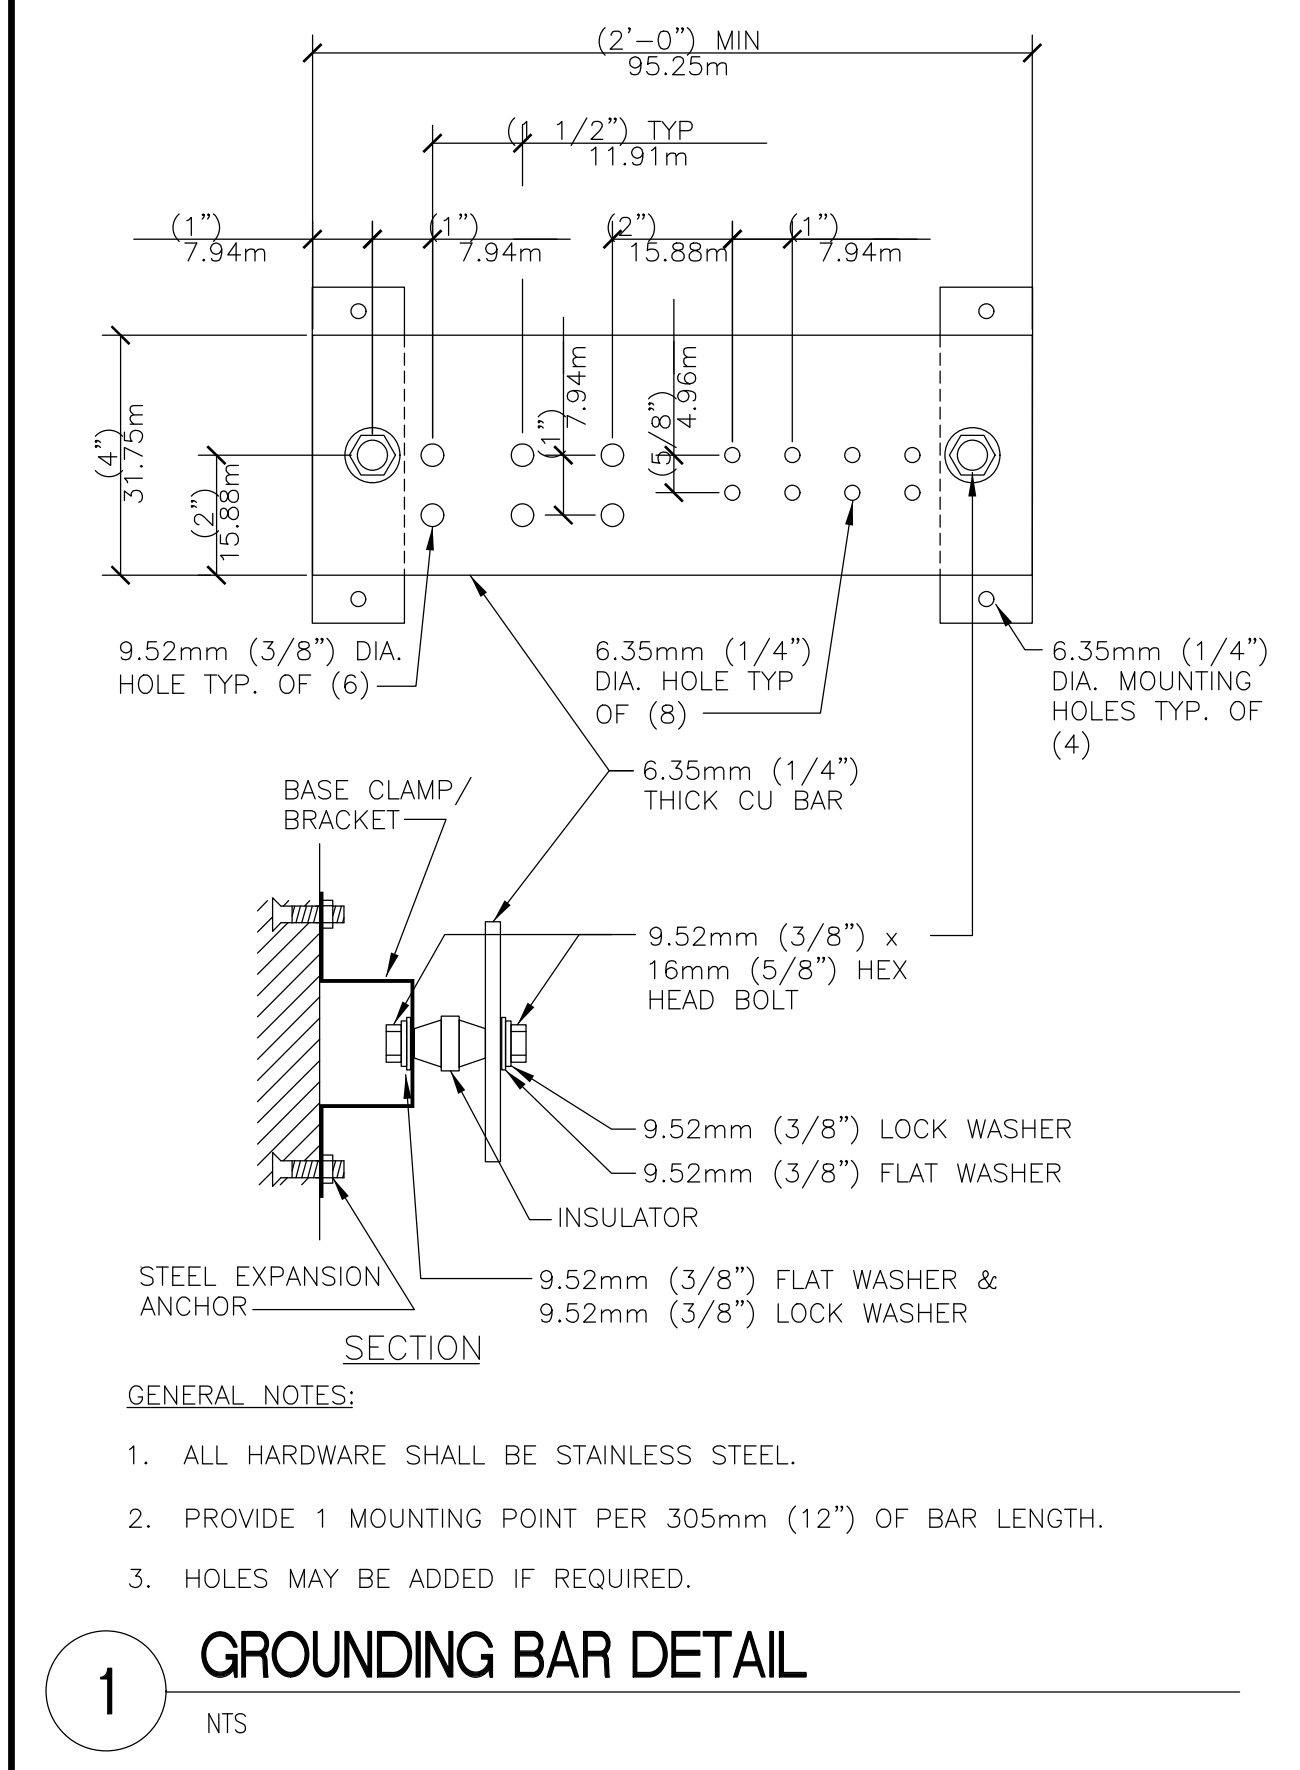

Additions:	Date
Revisions:	Date
SCHEMATIC DESIGN (30%) SUBMISSION	03/25/15
DESIGN DEVELOPMENT (60%) SUBMISSION	09/11/15
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BID DOCUMENTS	03/17/16

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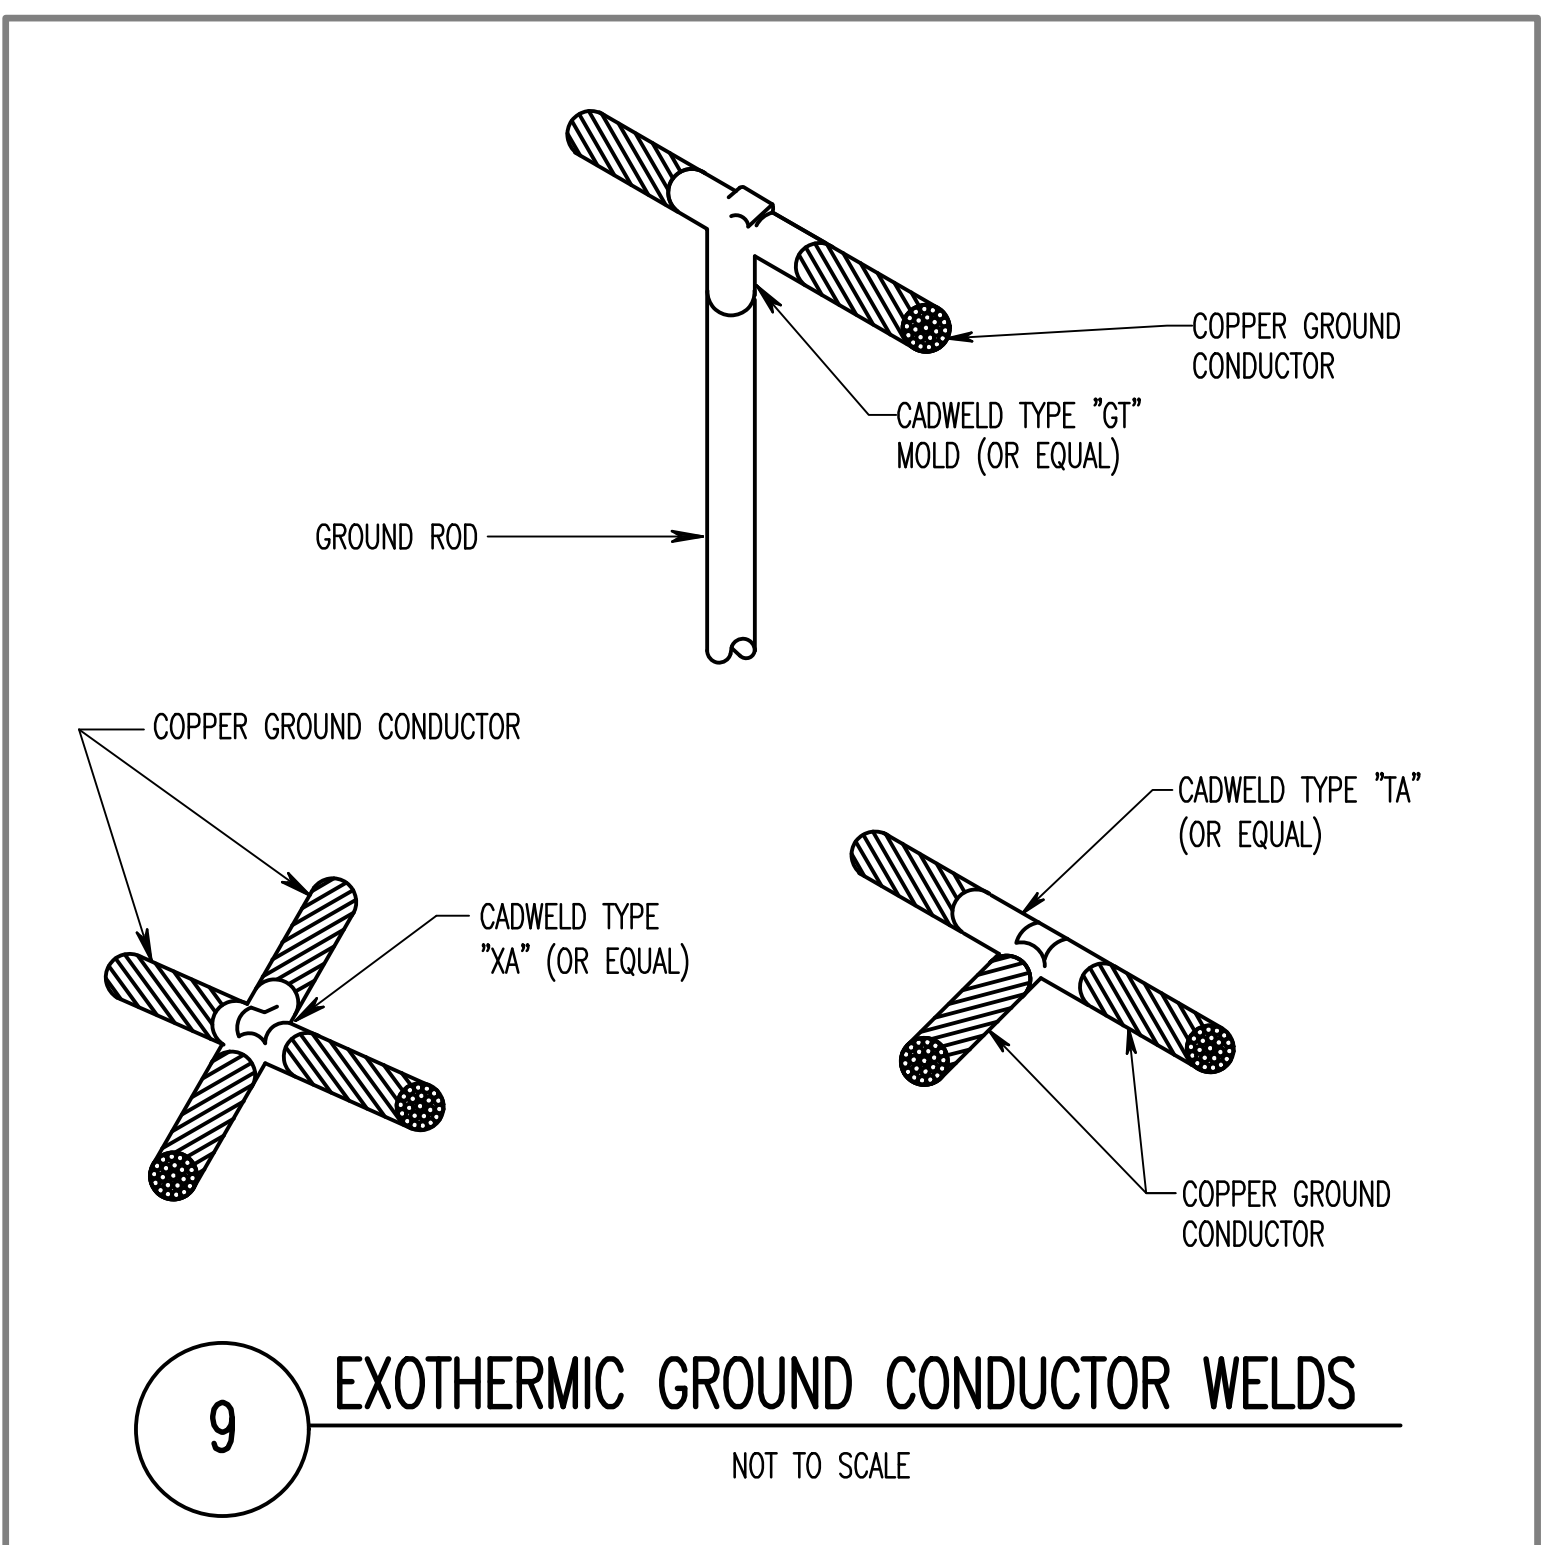
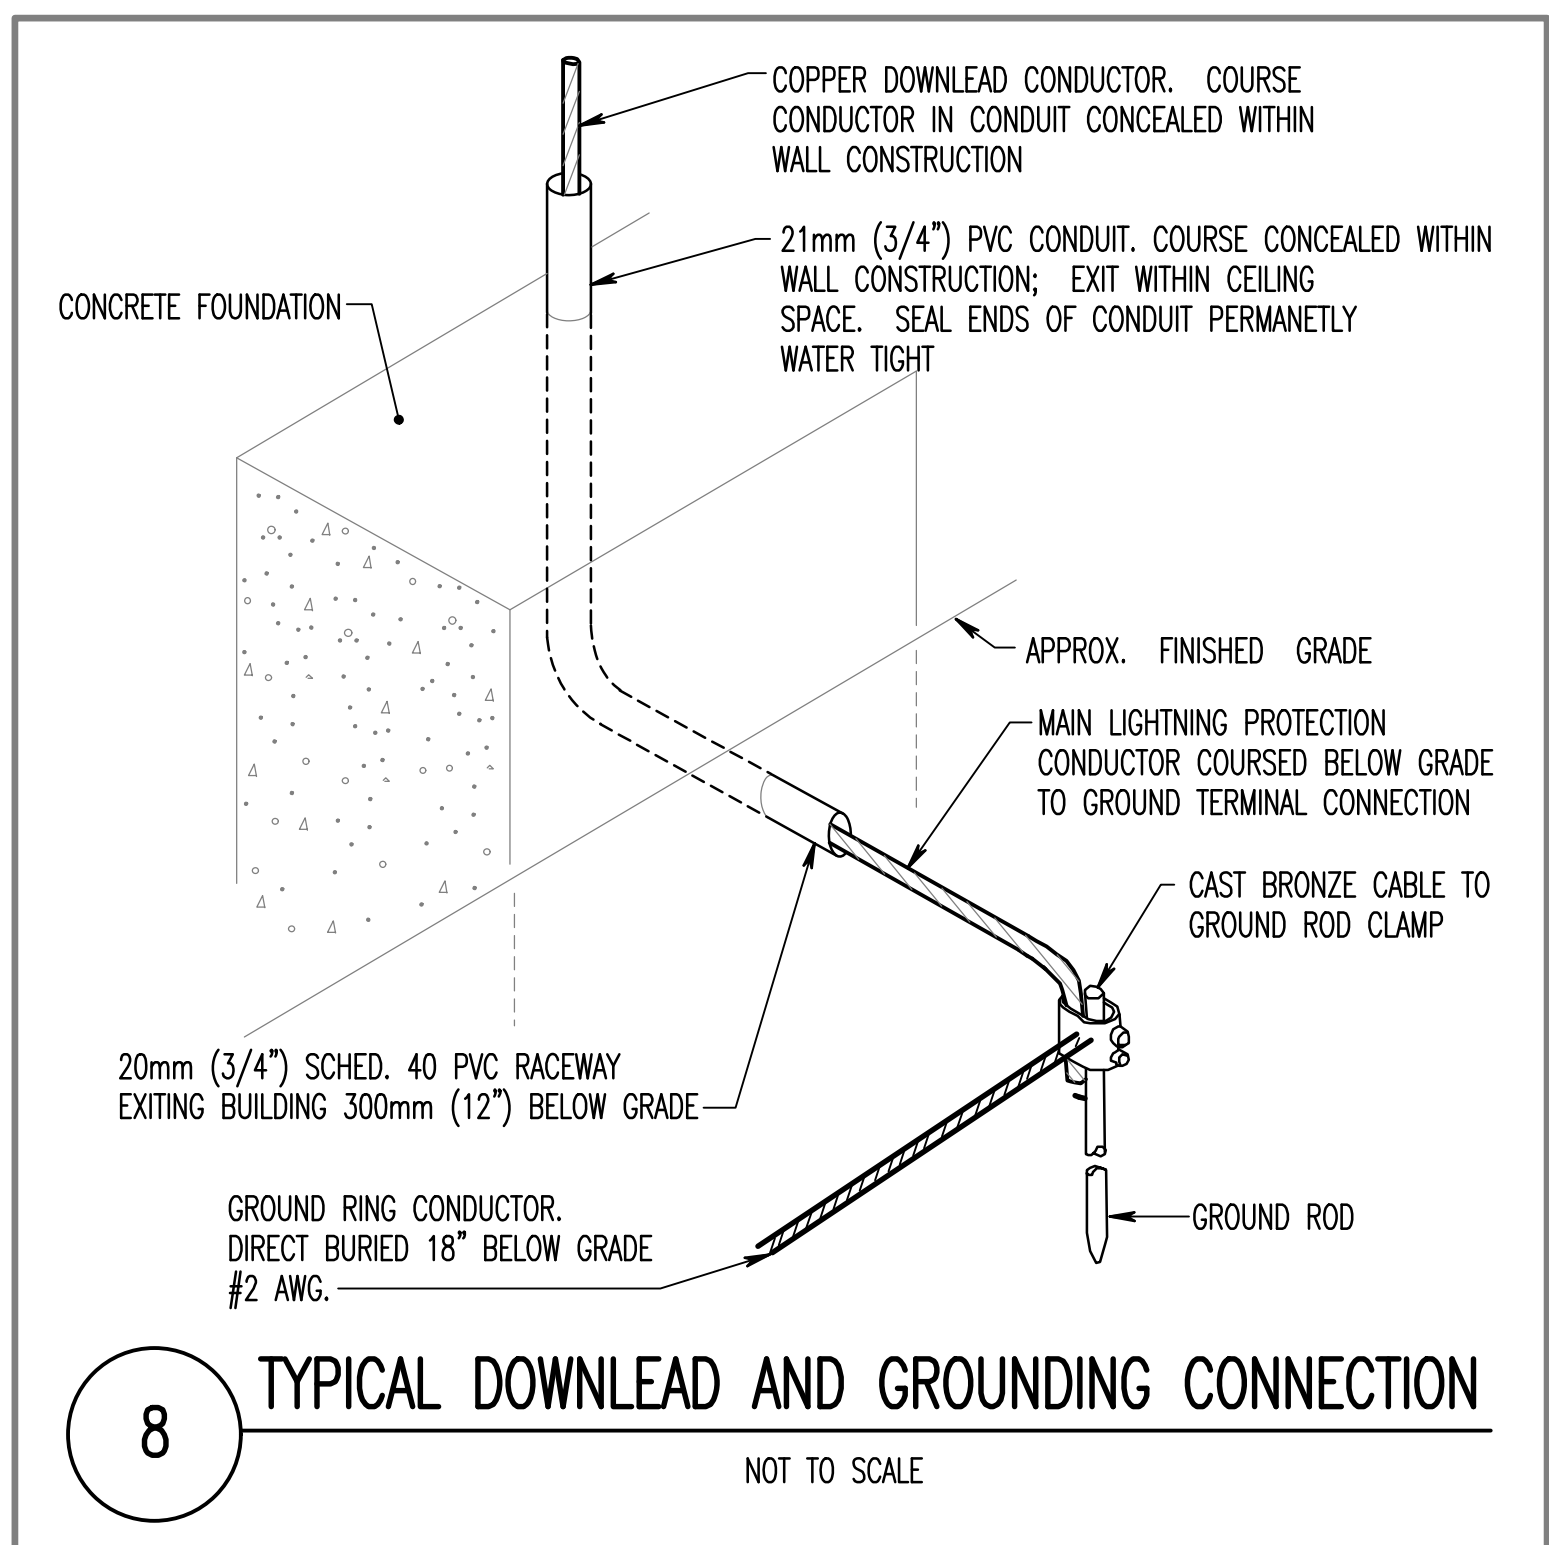
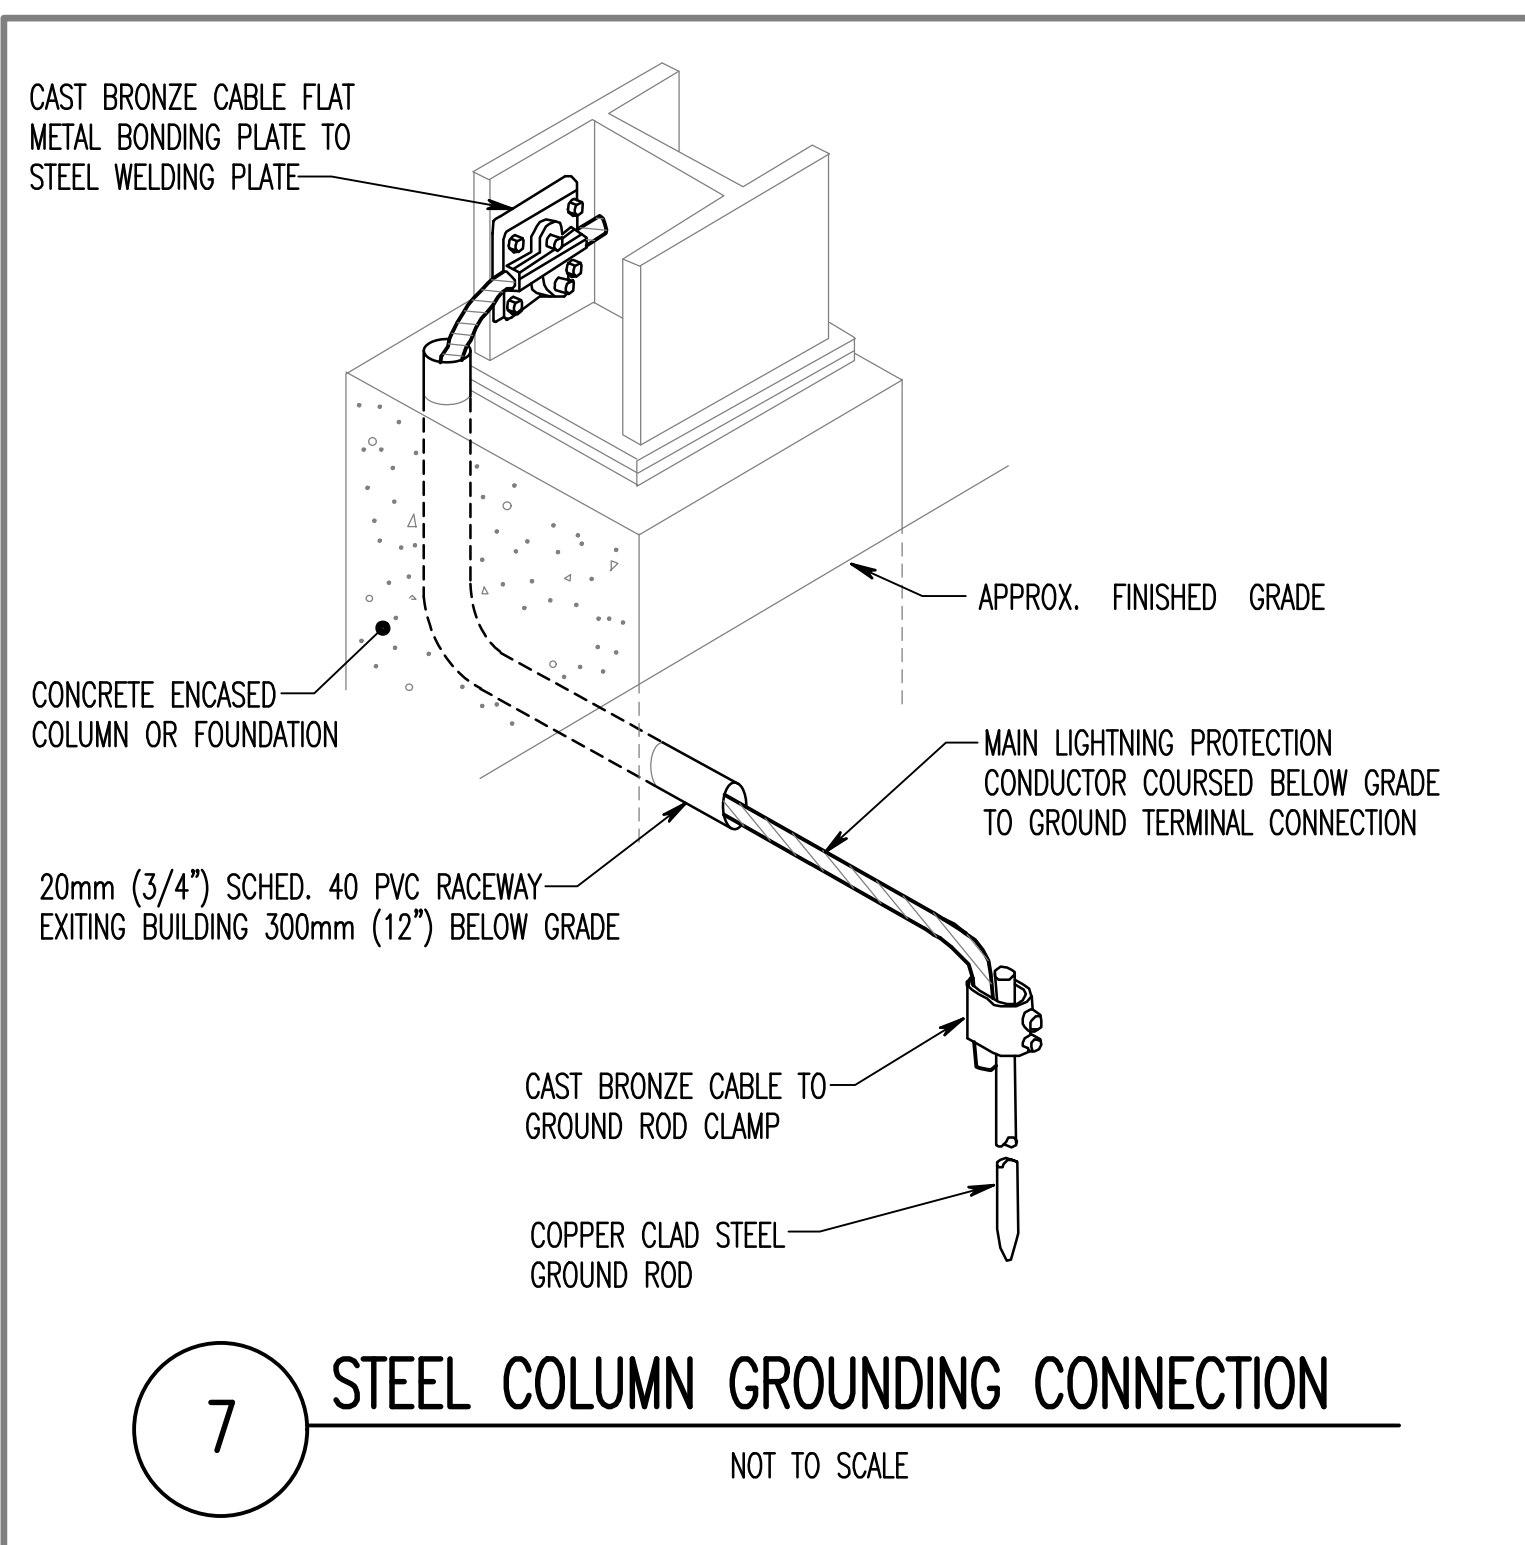
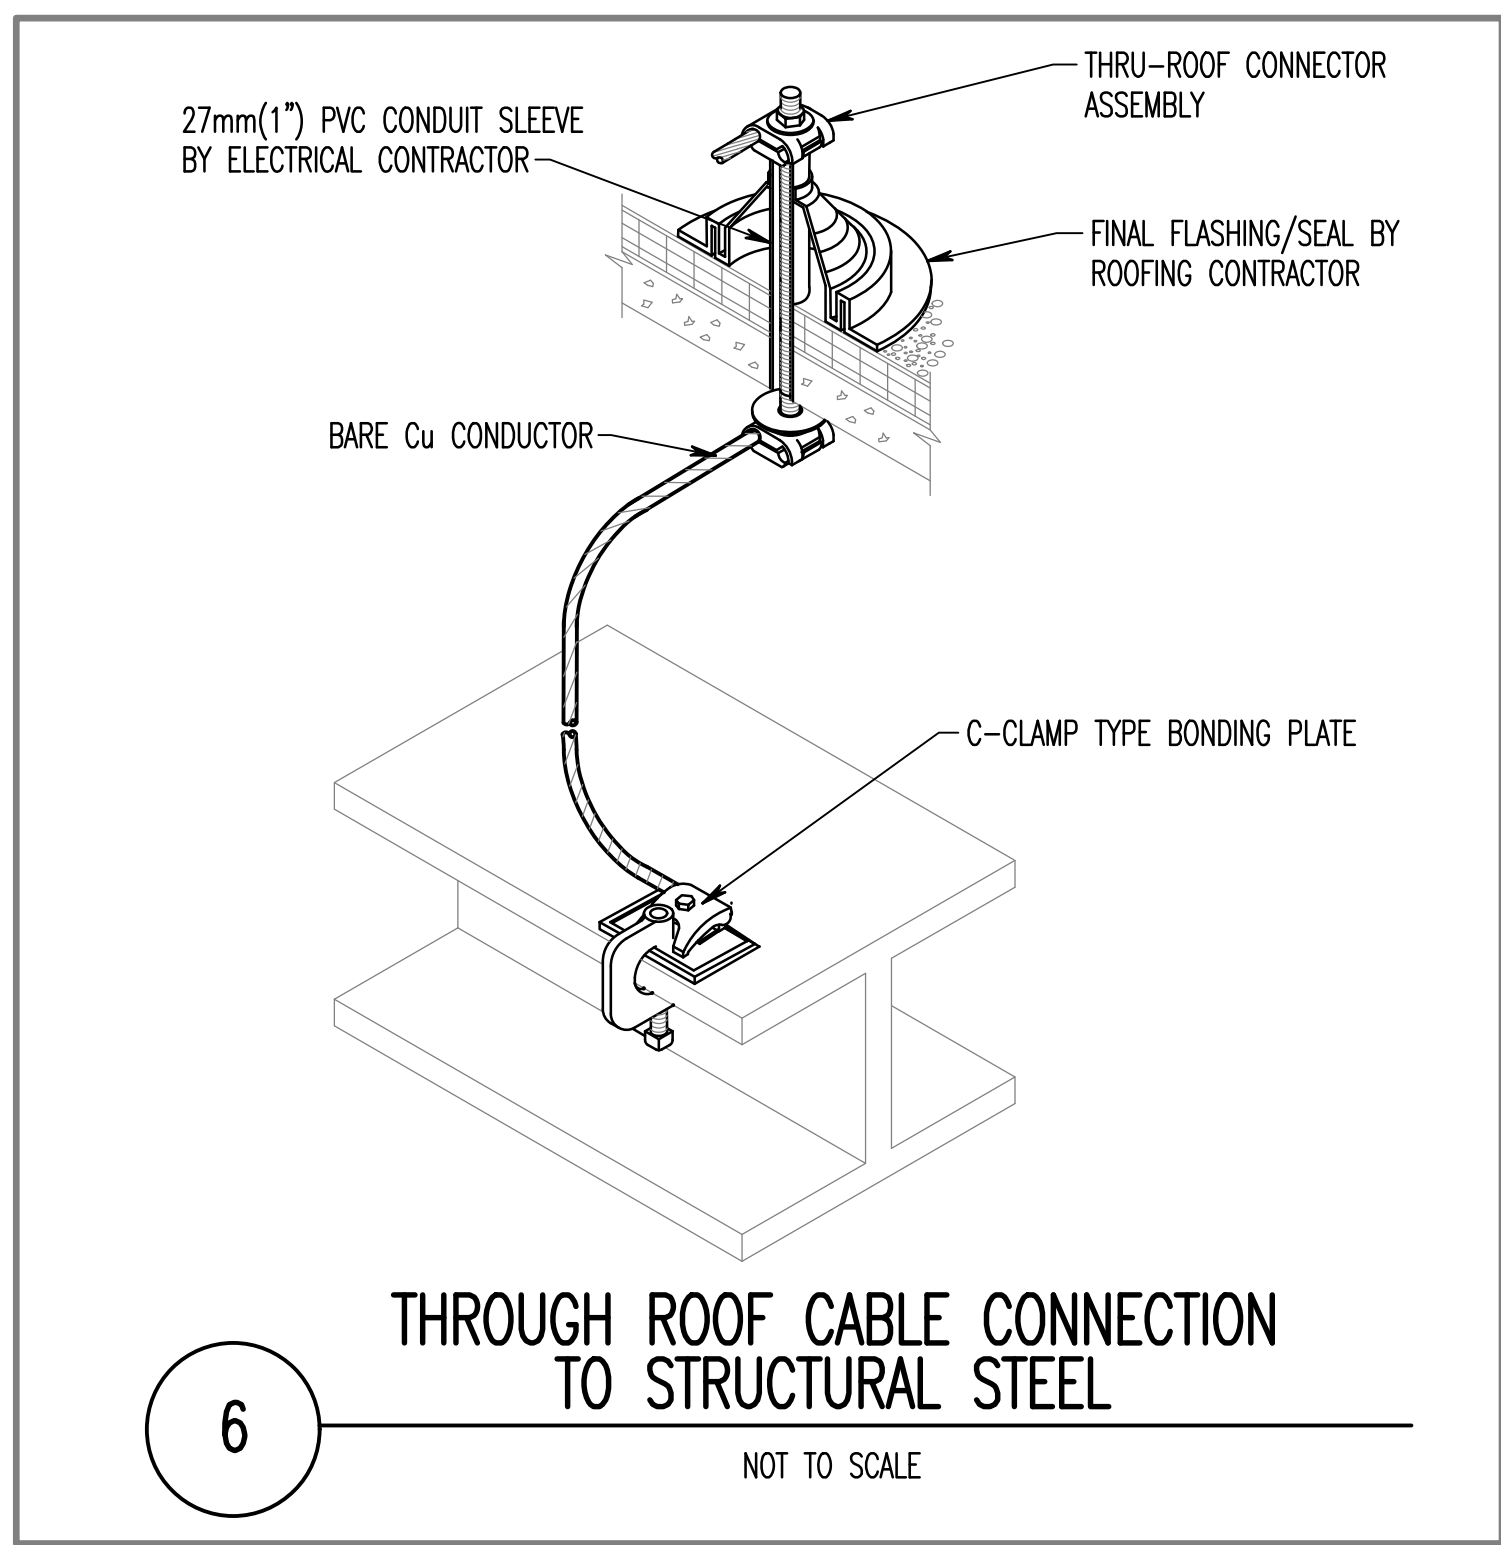
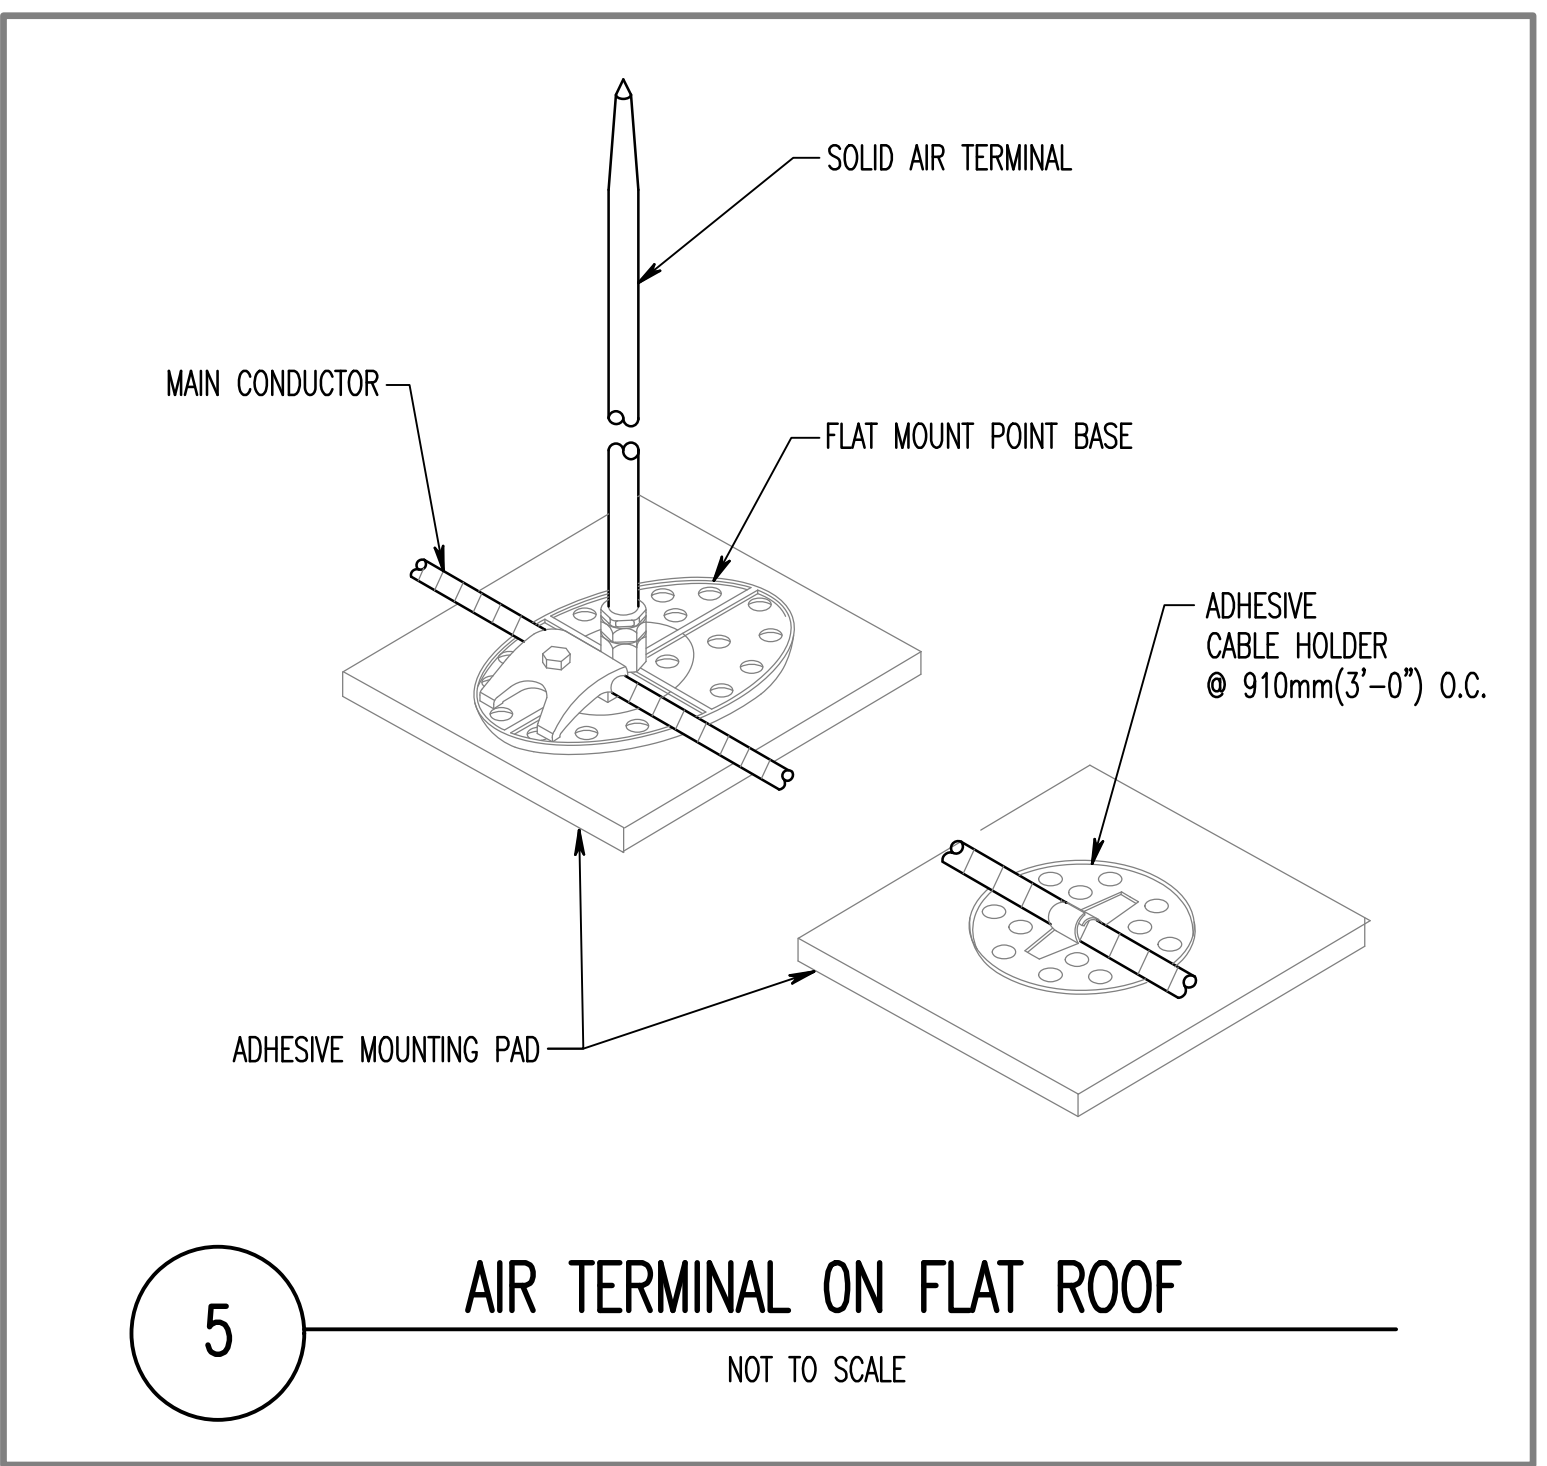
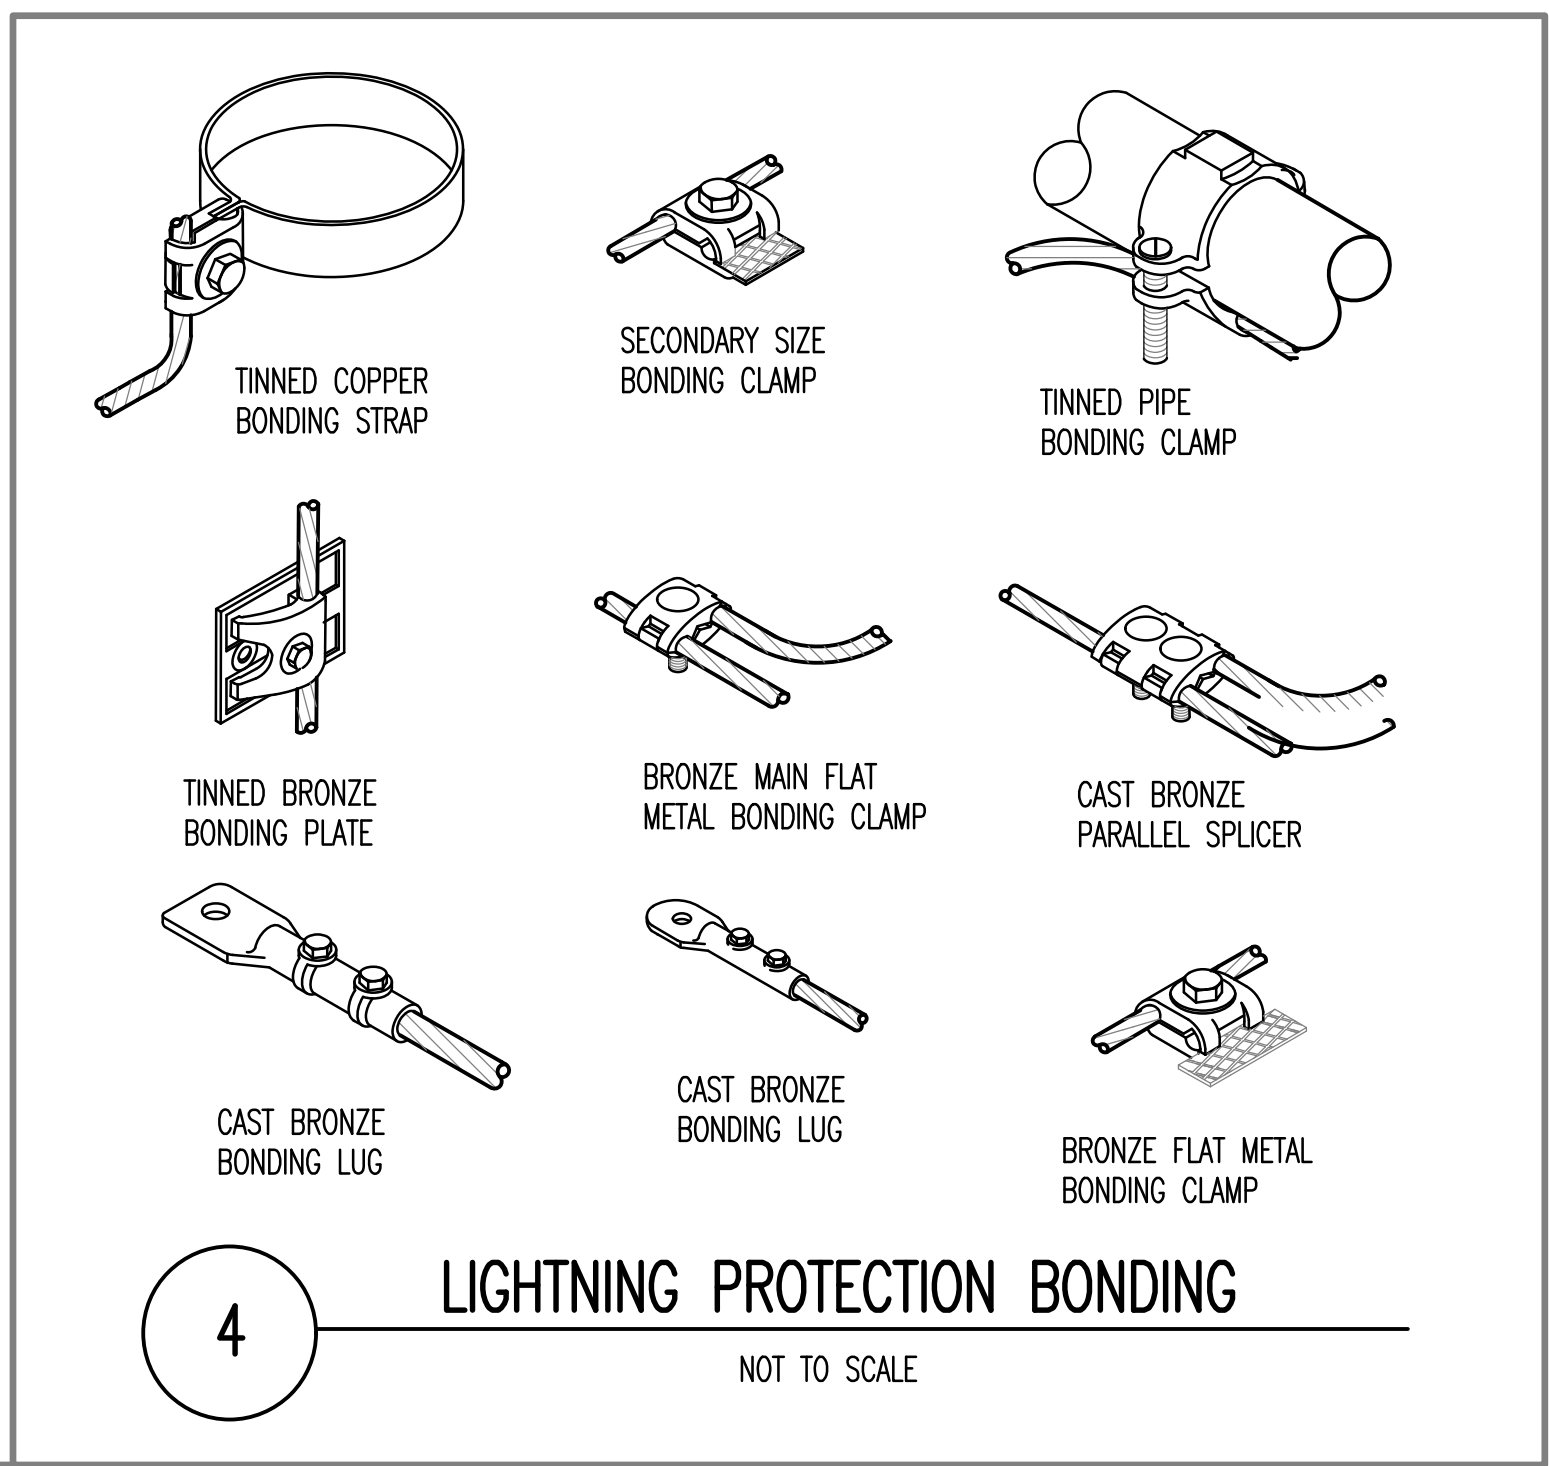
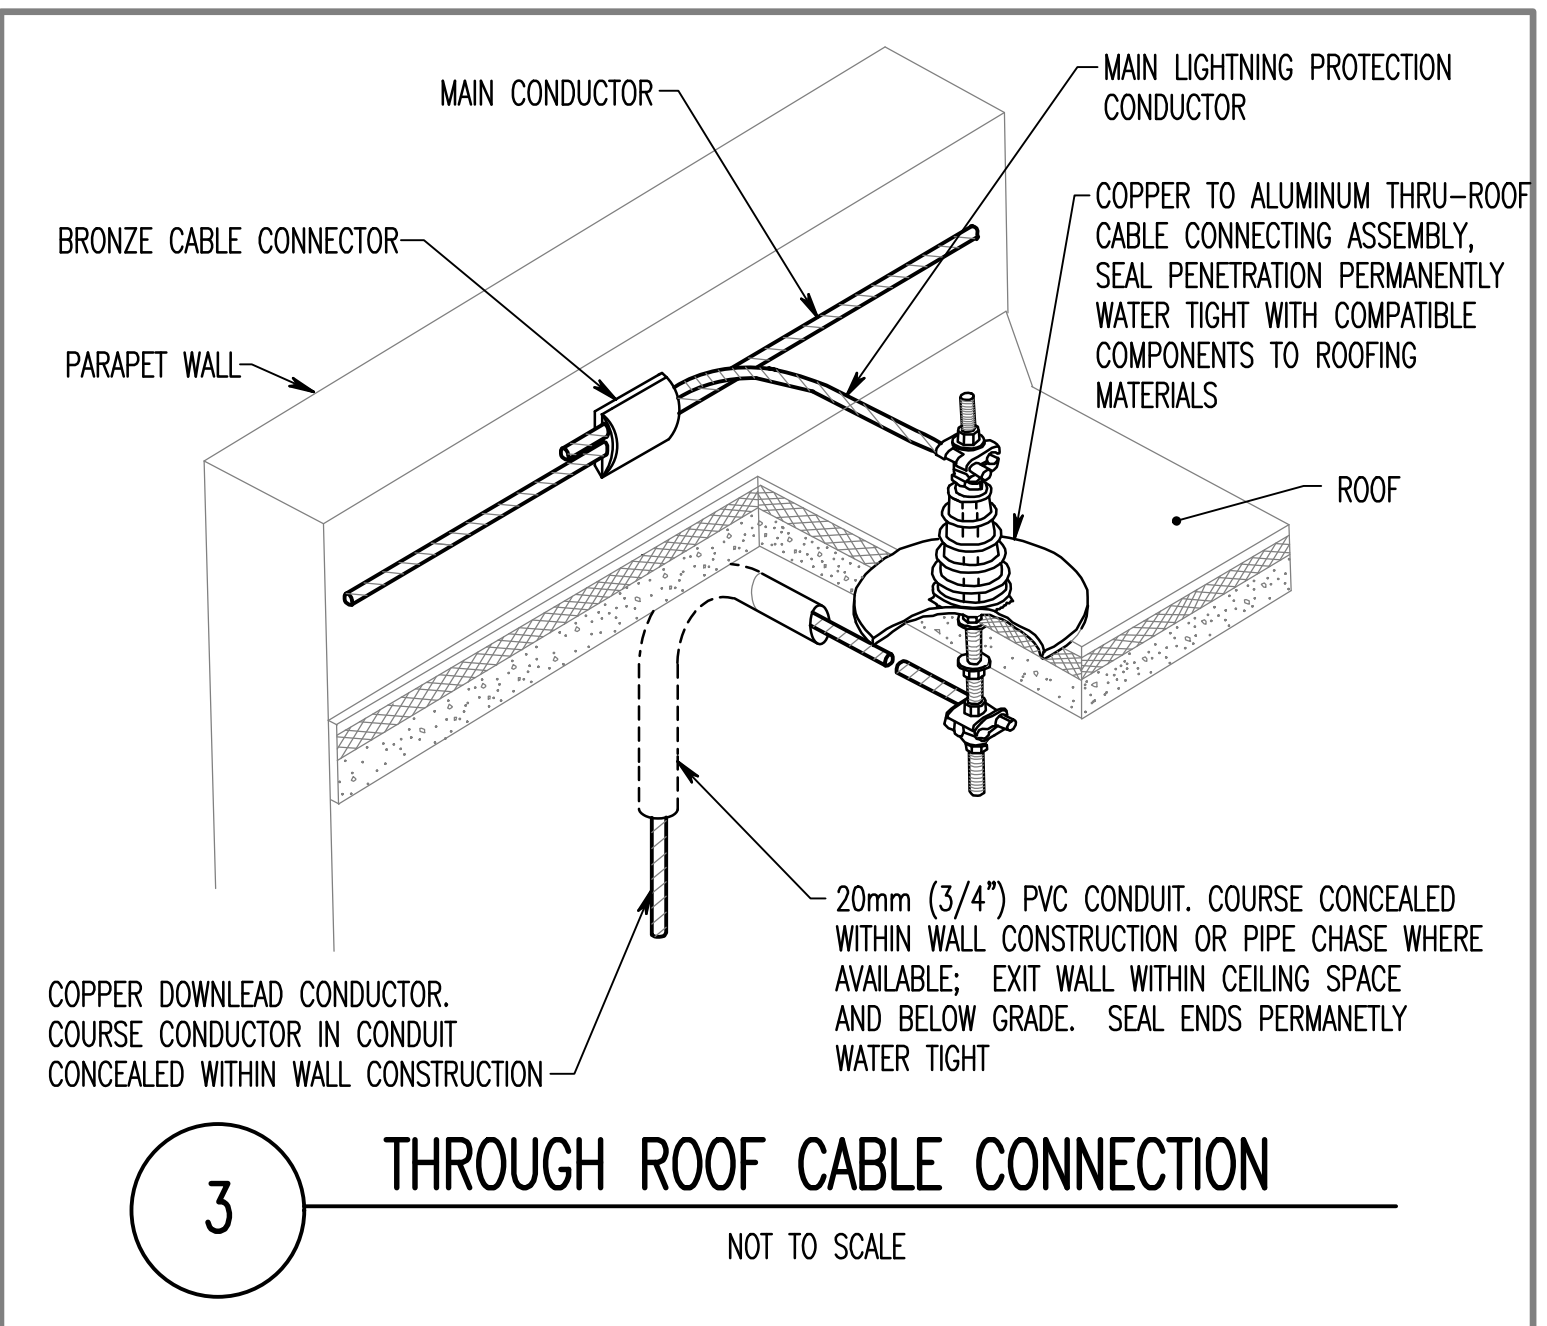
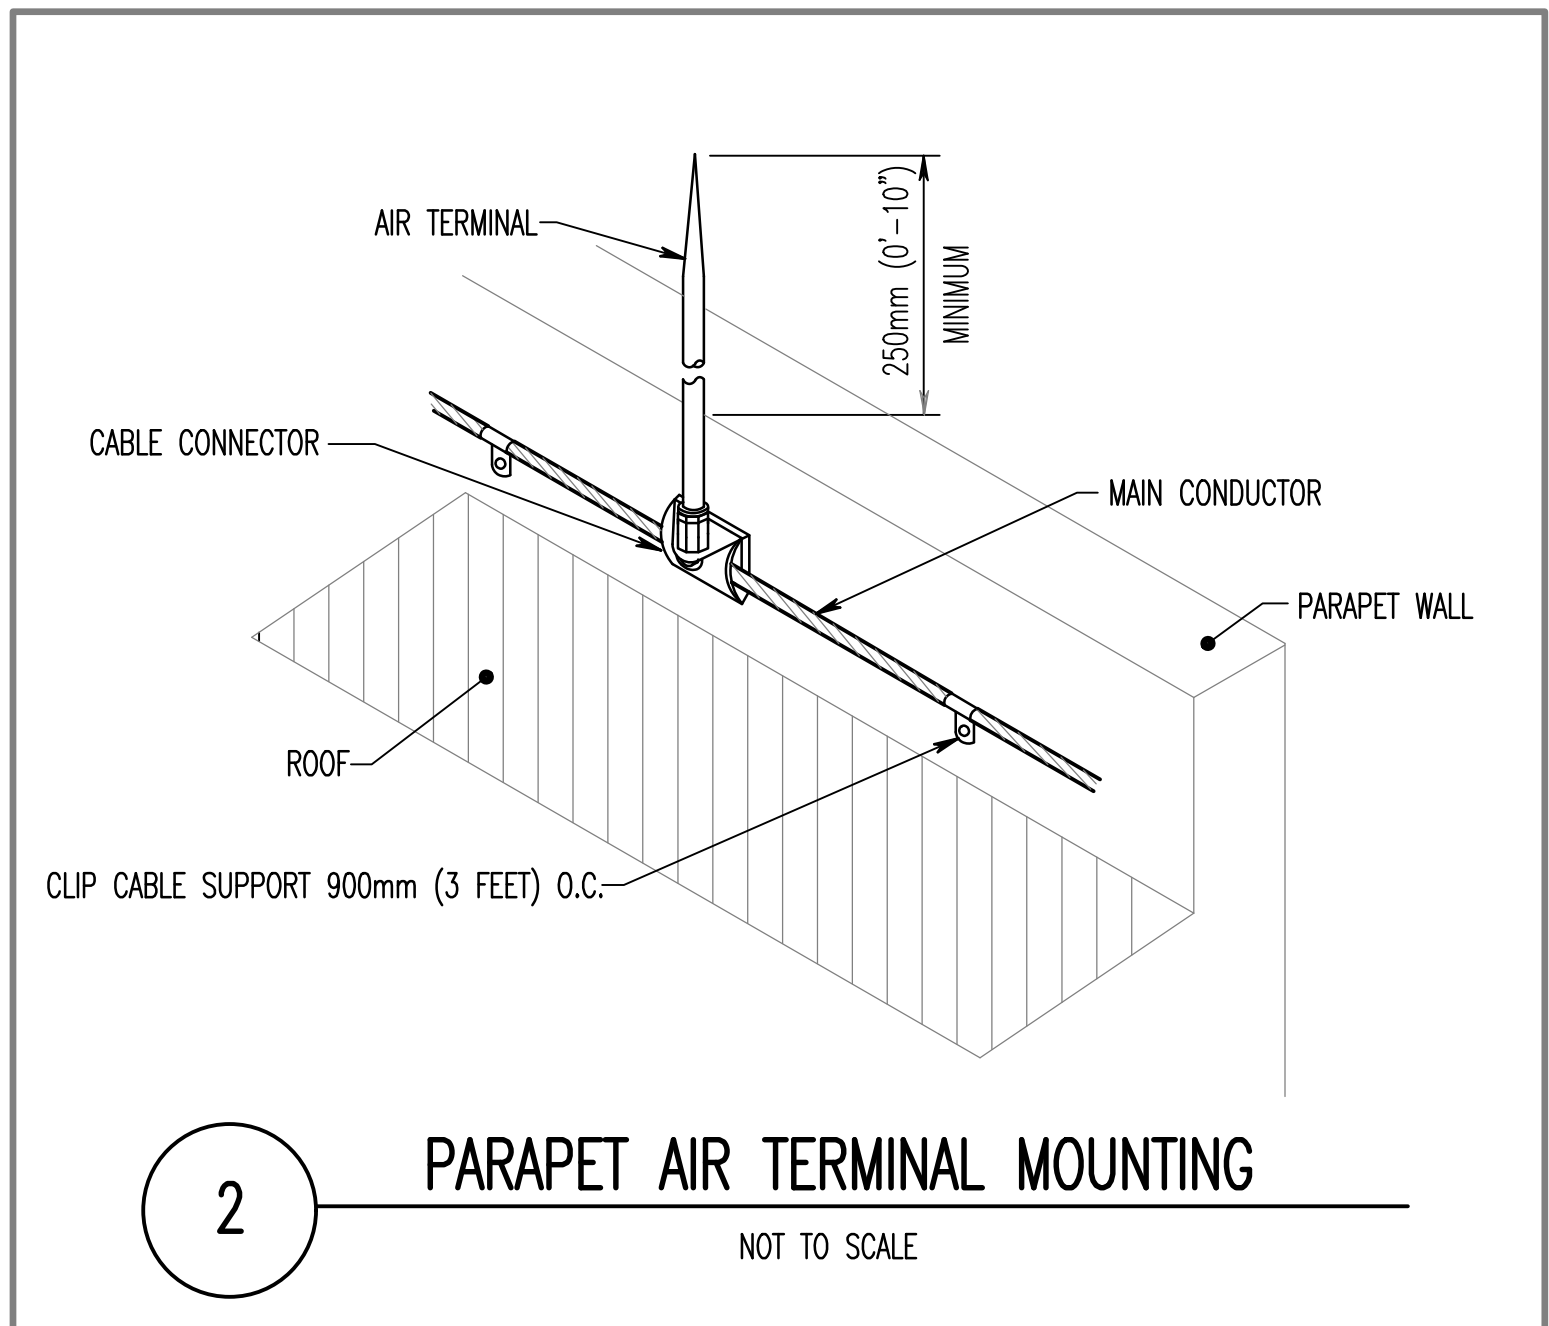
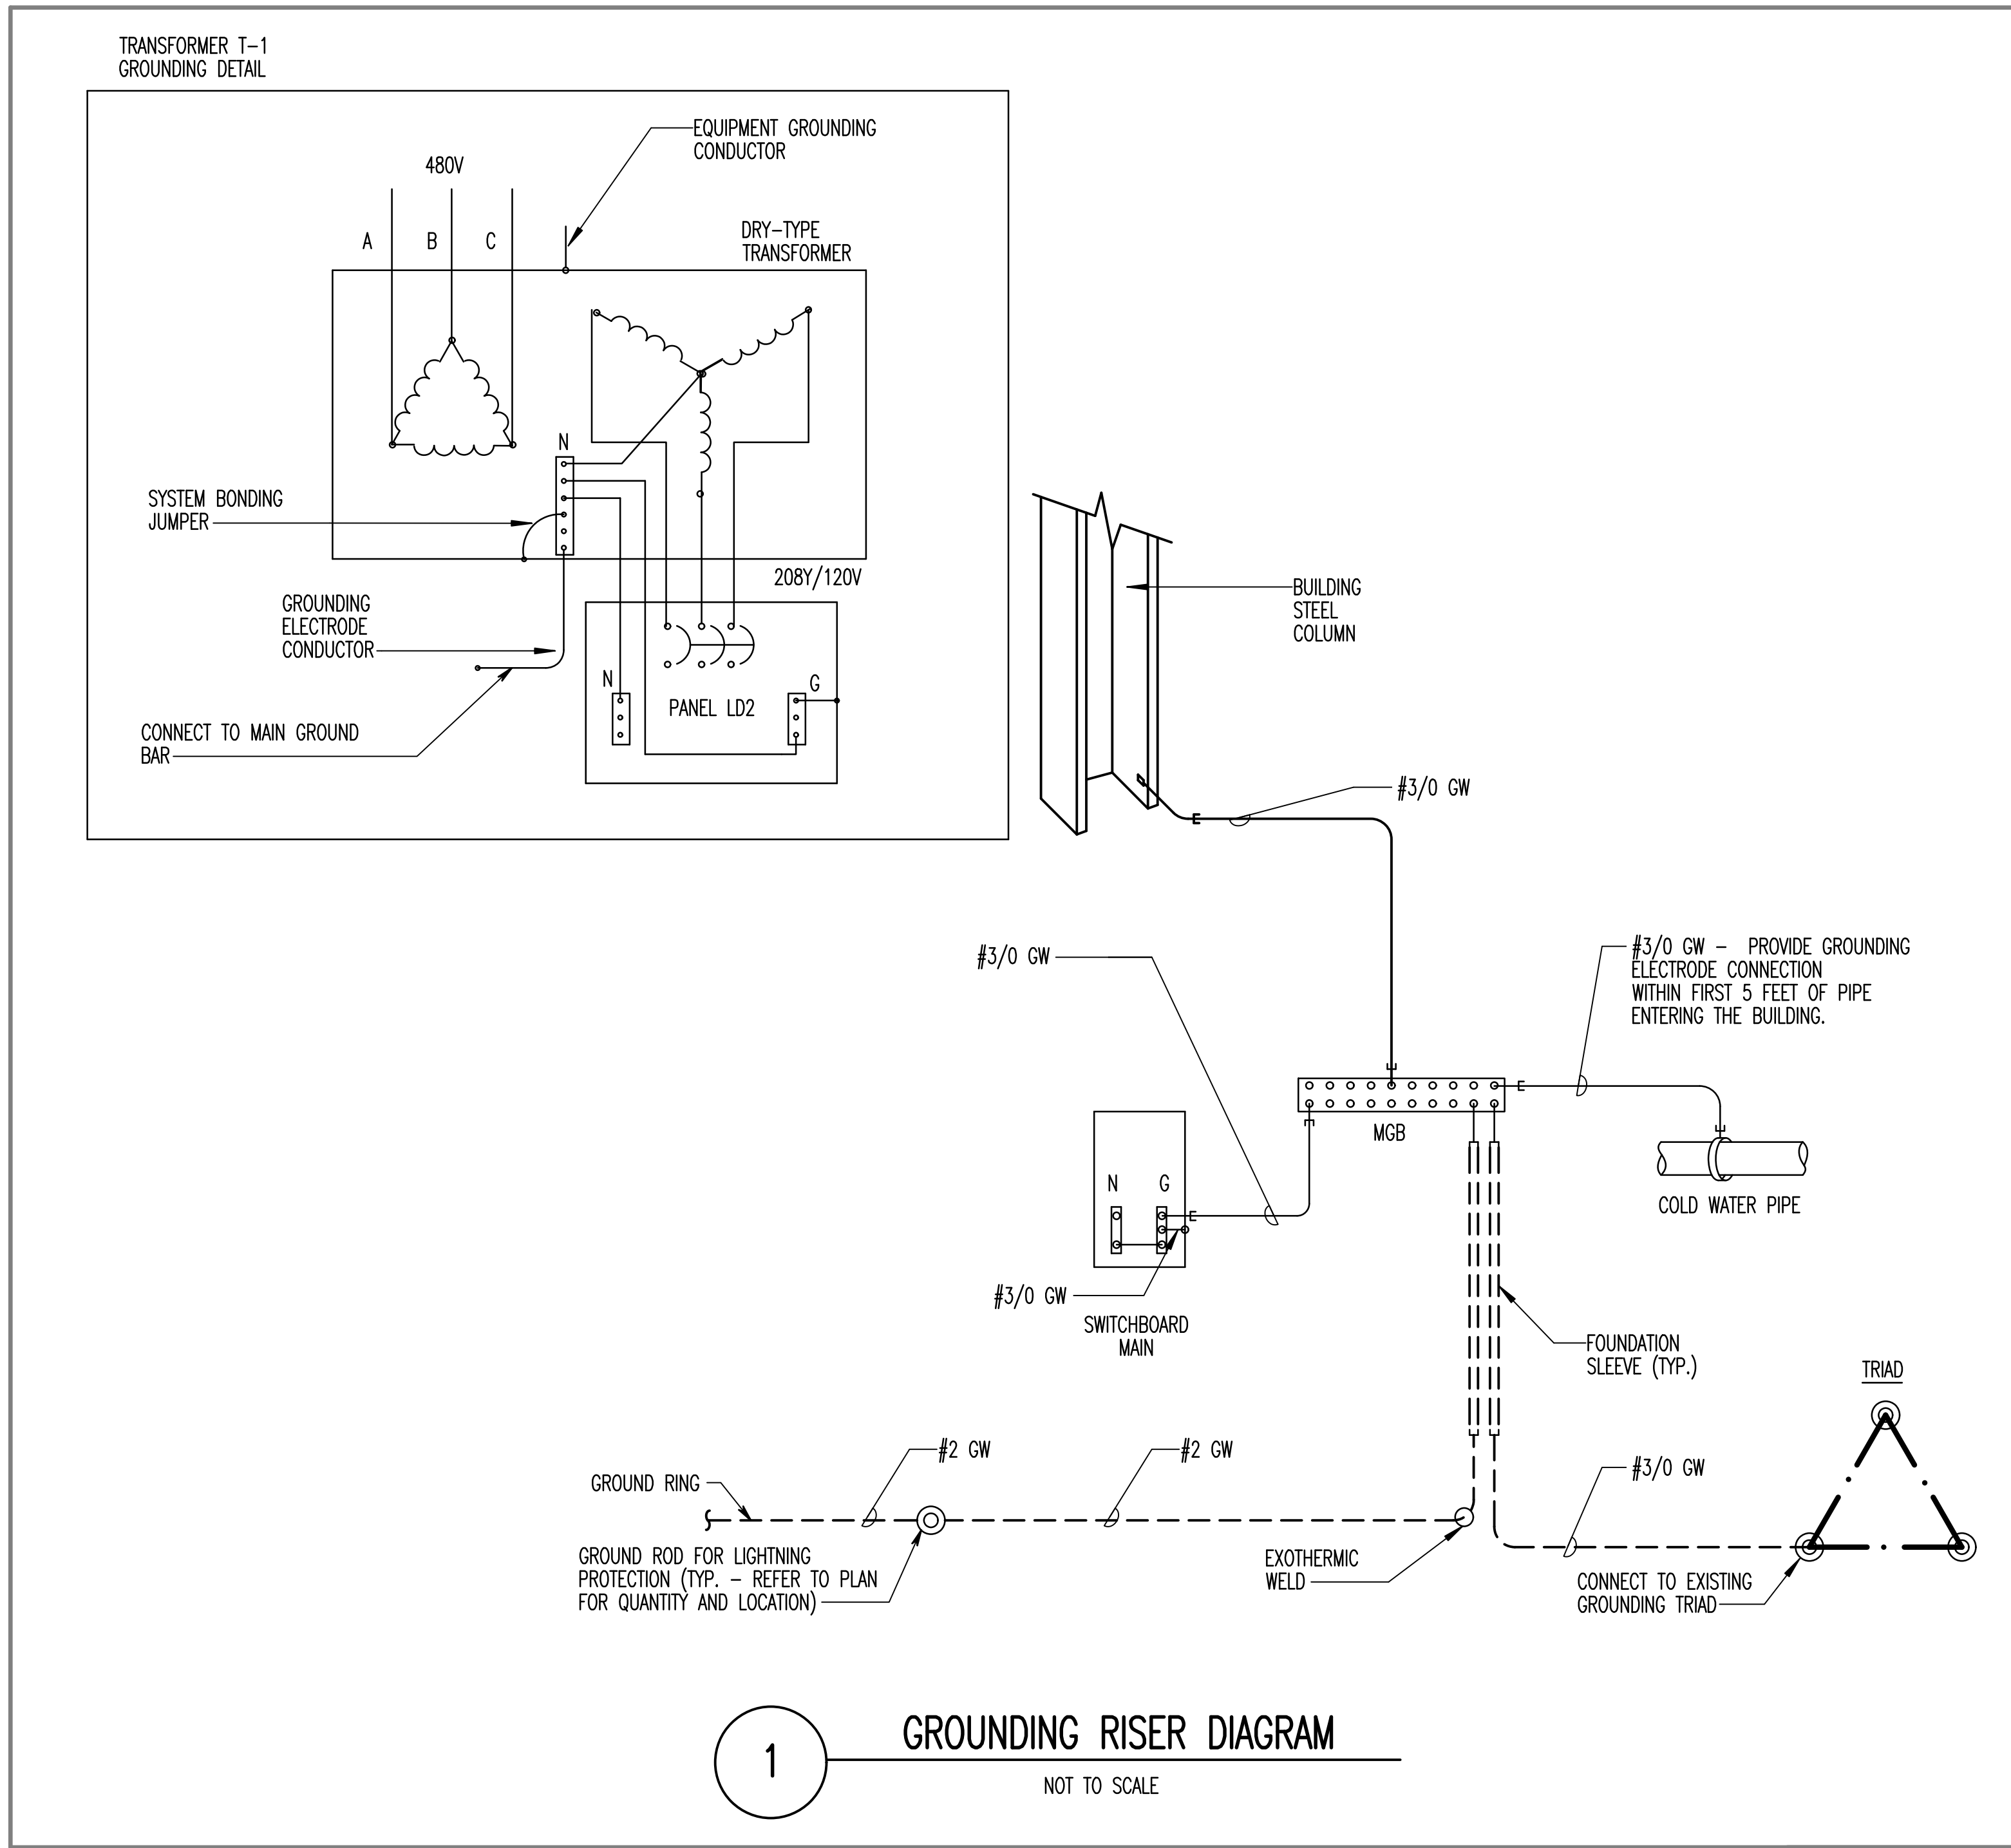
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Approved: Engineering Projects Supervisor
Approved: Infection Control Officer

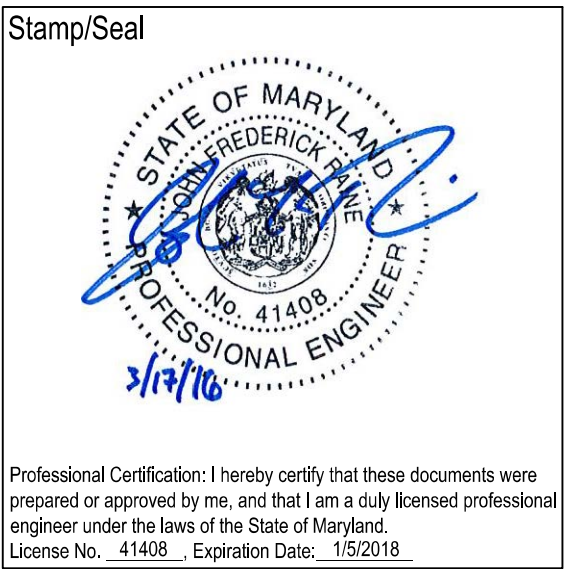Drawing Title
ELECTRICAL DETAILS
Approved: Associate Director for Operations
Approved: Director, Medical Center

Project Title			
WAREHOUSE RENOVATION & EXPANSION			
Scale	Building Number	Checked	Drawn
NONE	360	JFR	MLS
Location			
PERRY POINT, MD			


Date
03/17/16
VA Project Number
512-530
Drawing Number
E501





Additions:	Date
Revisions:	Date
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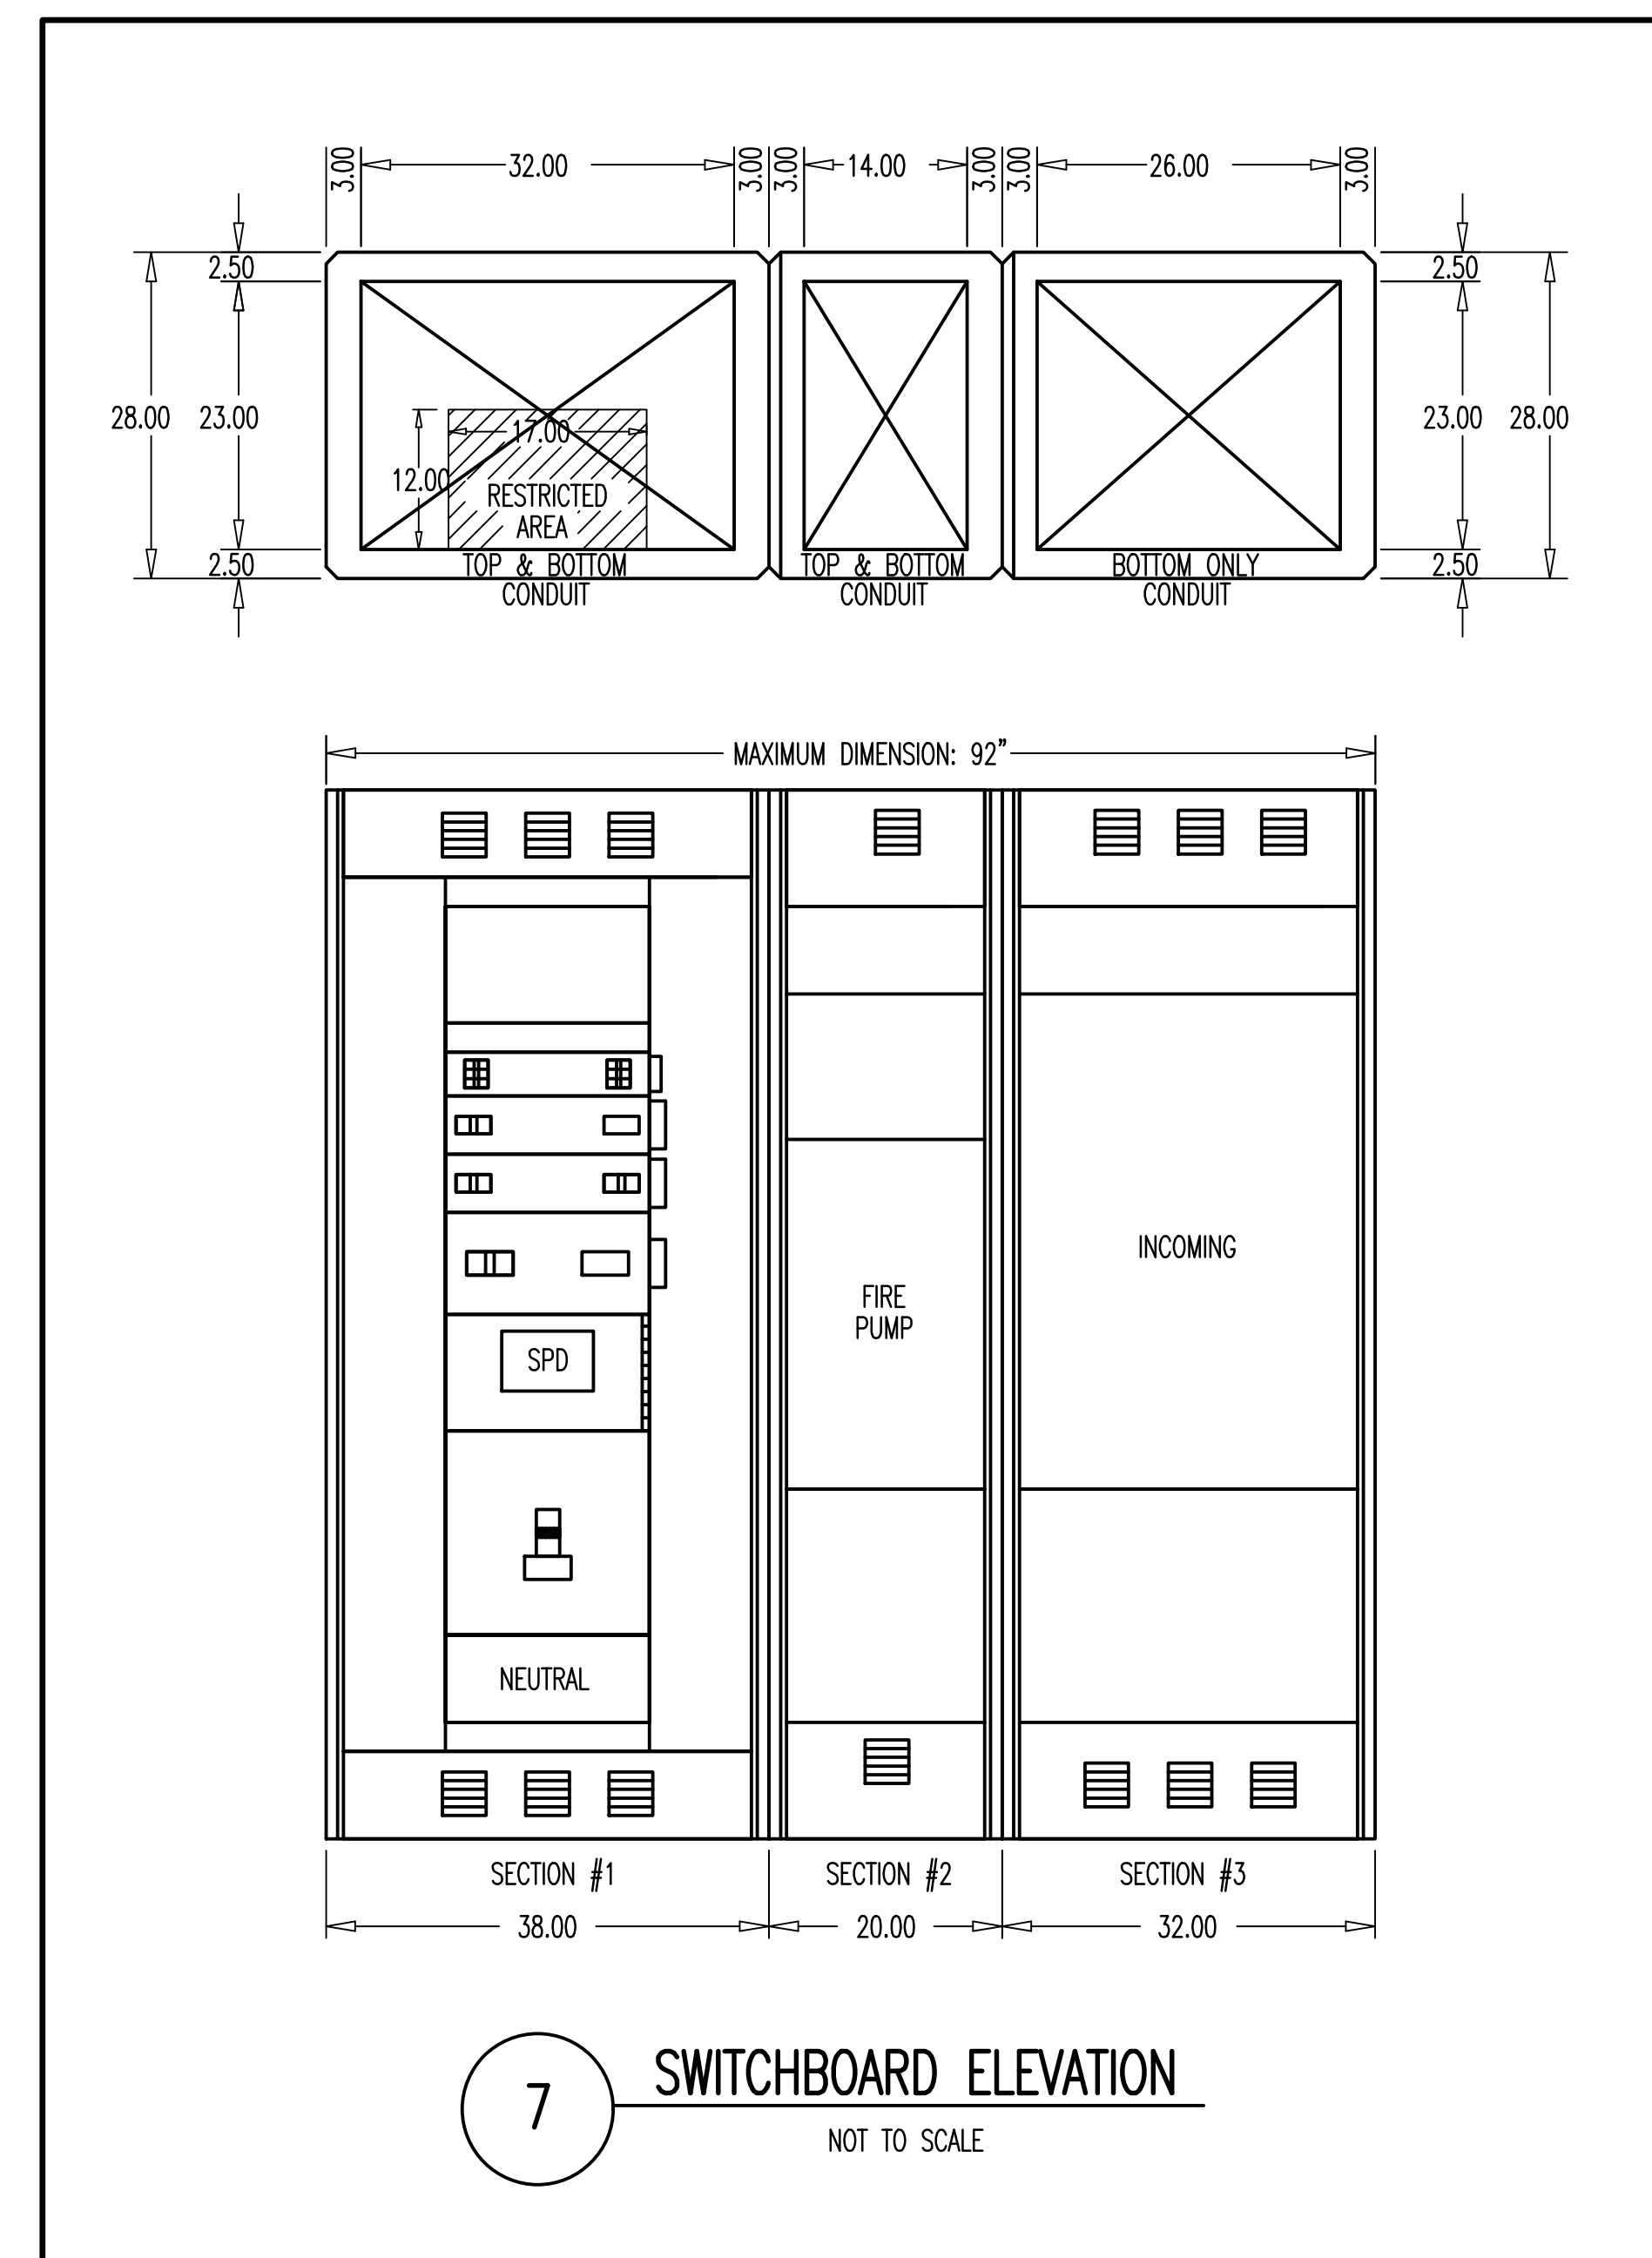
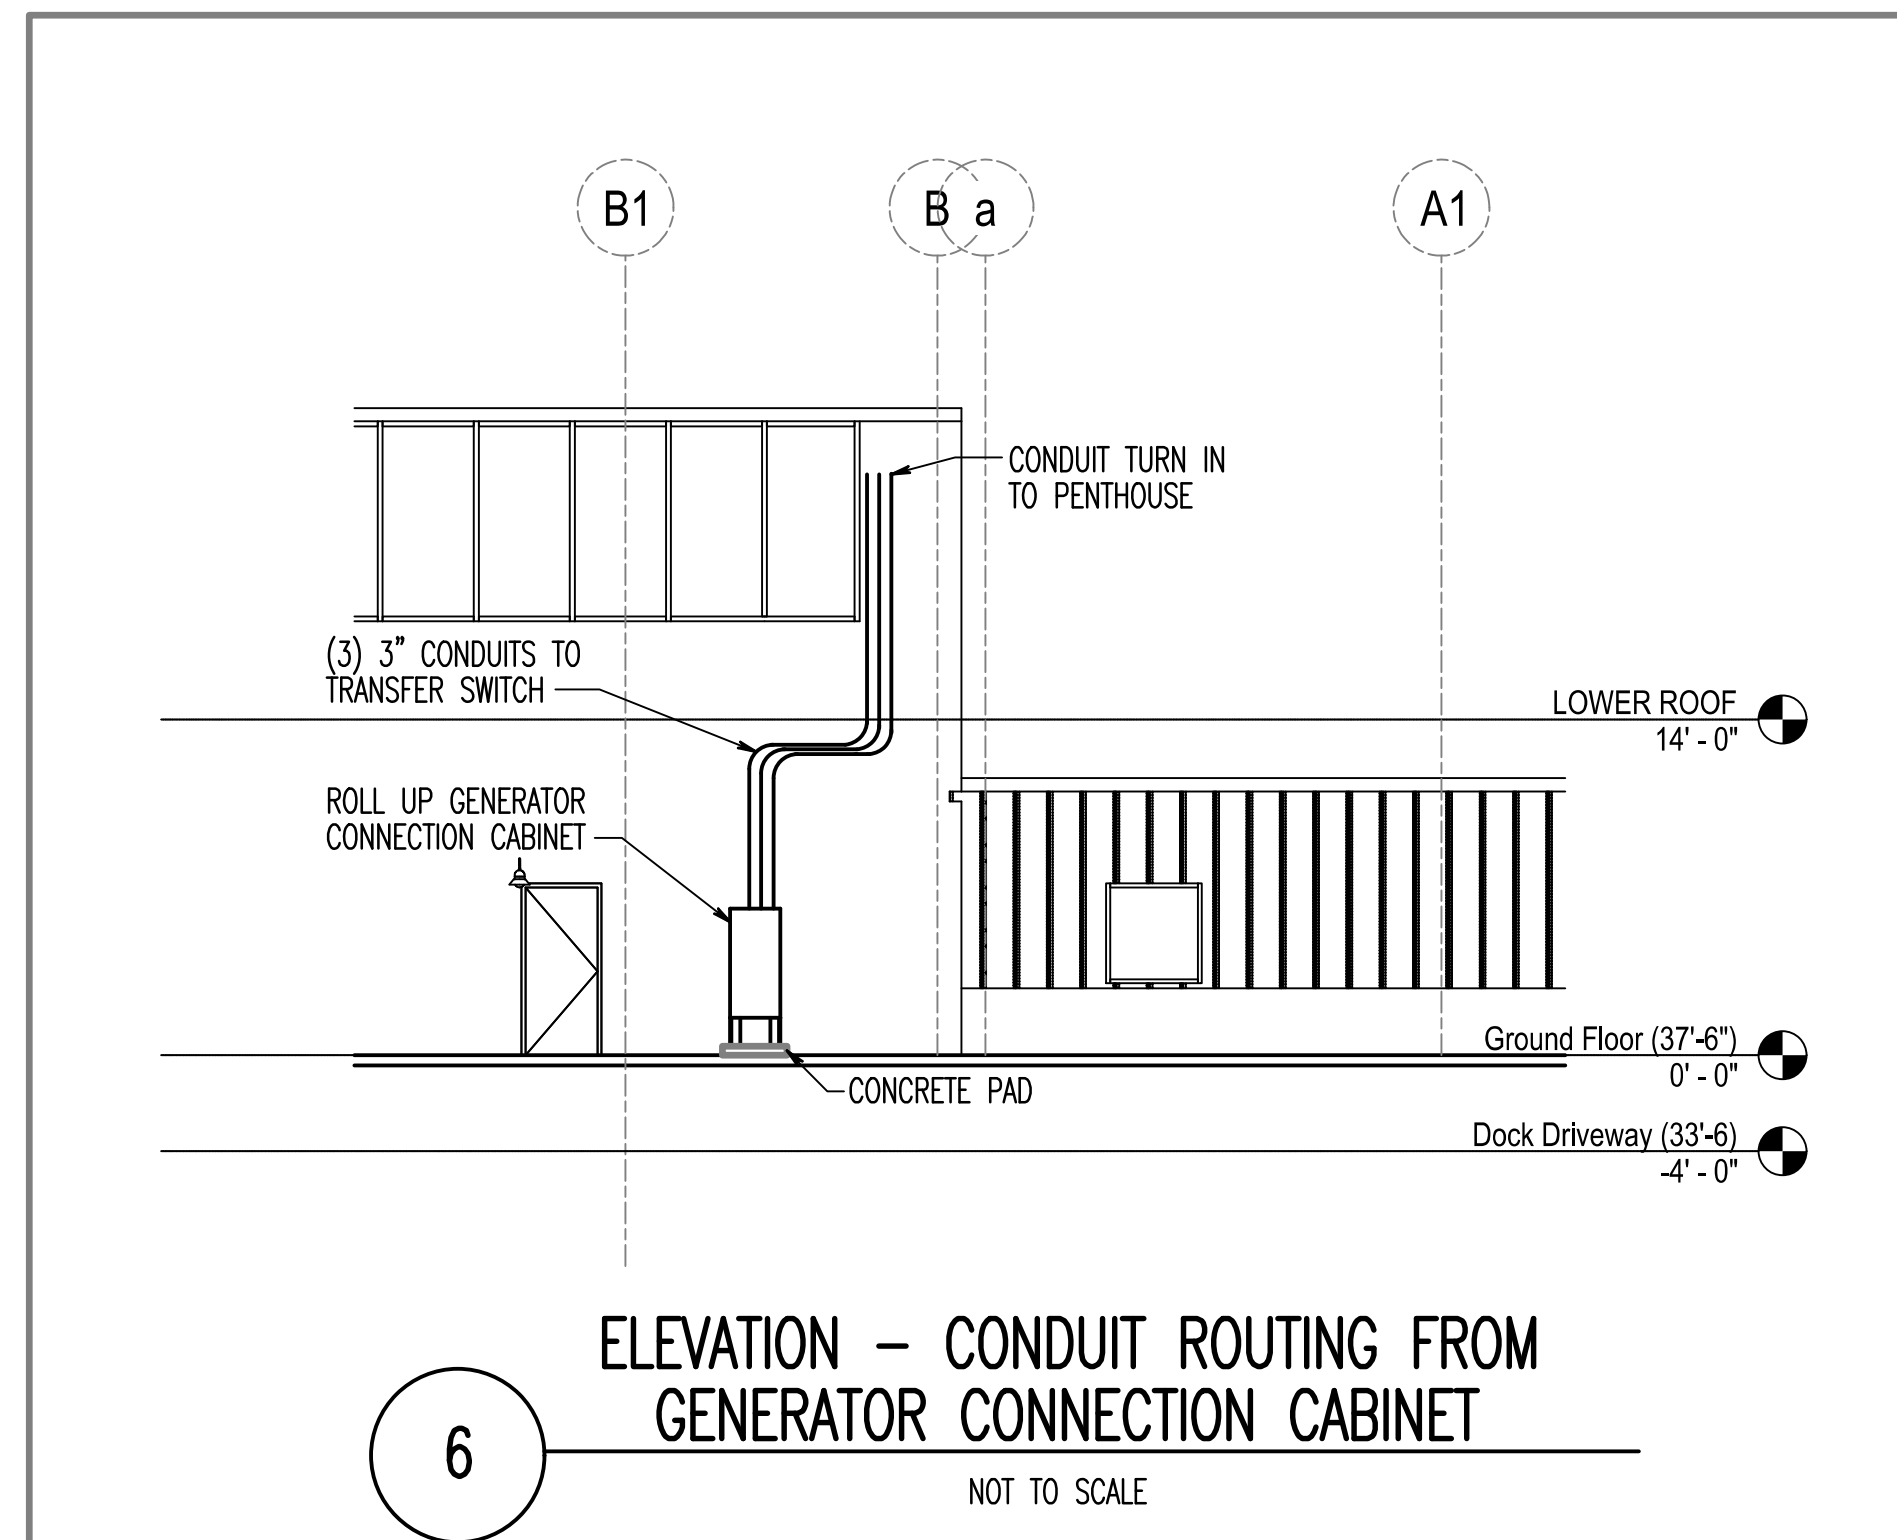
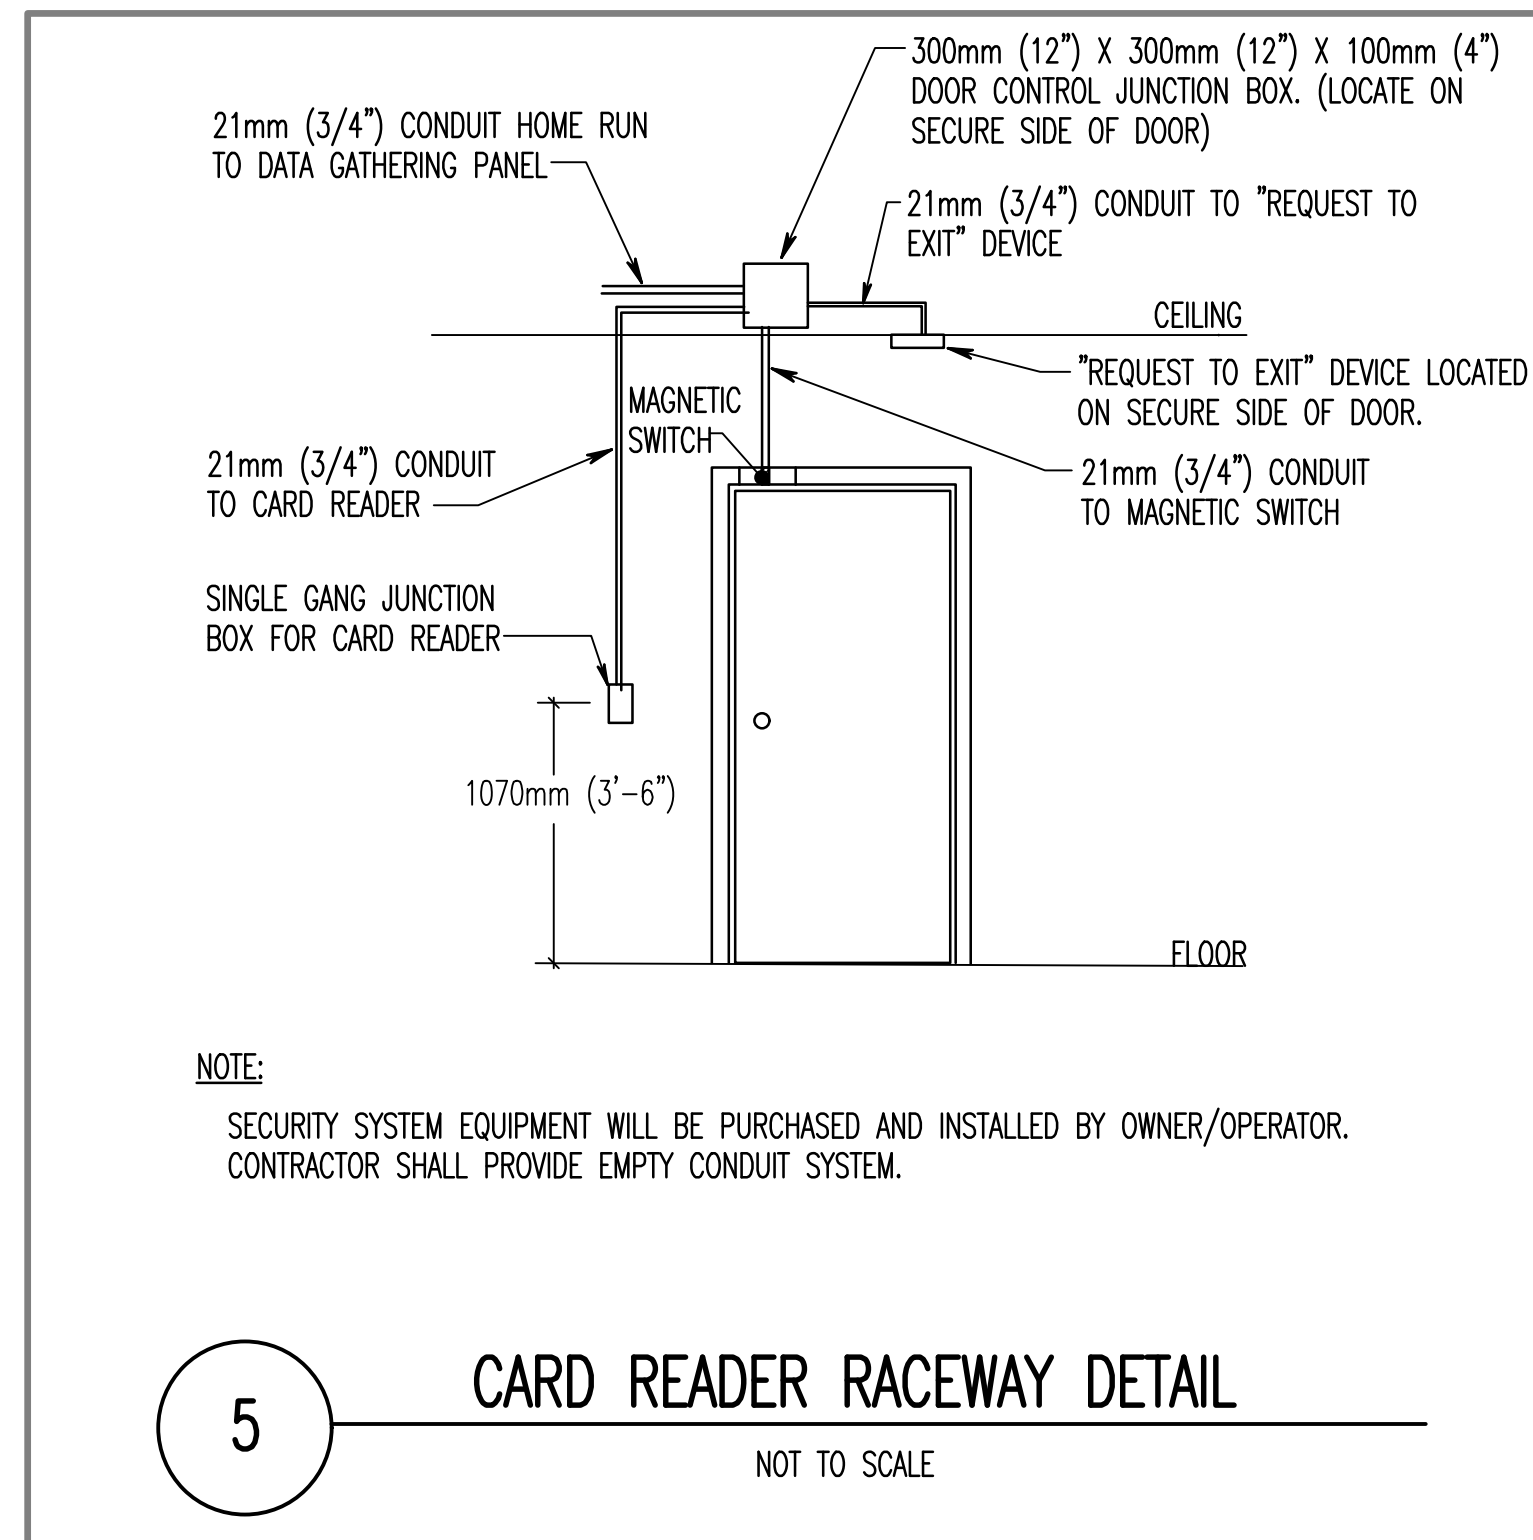
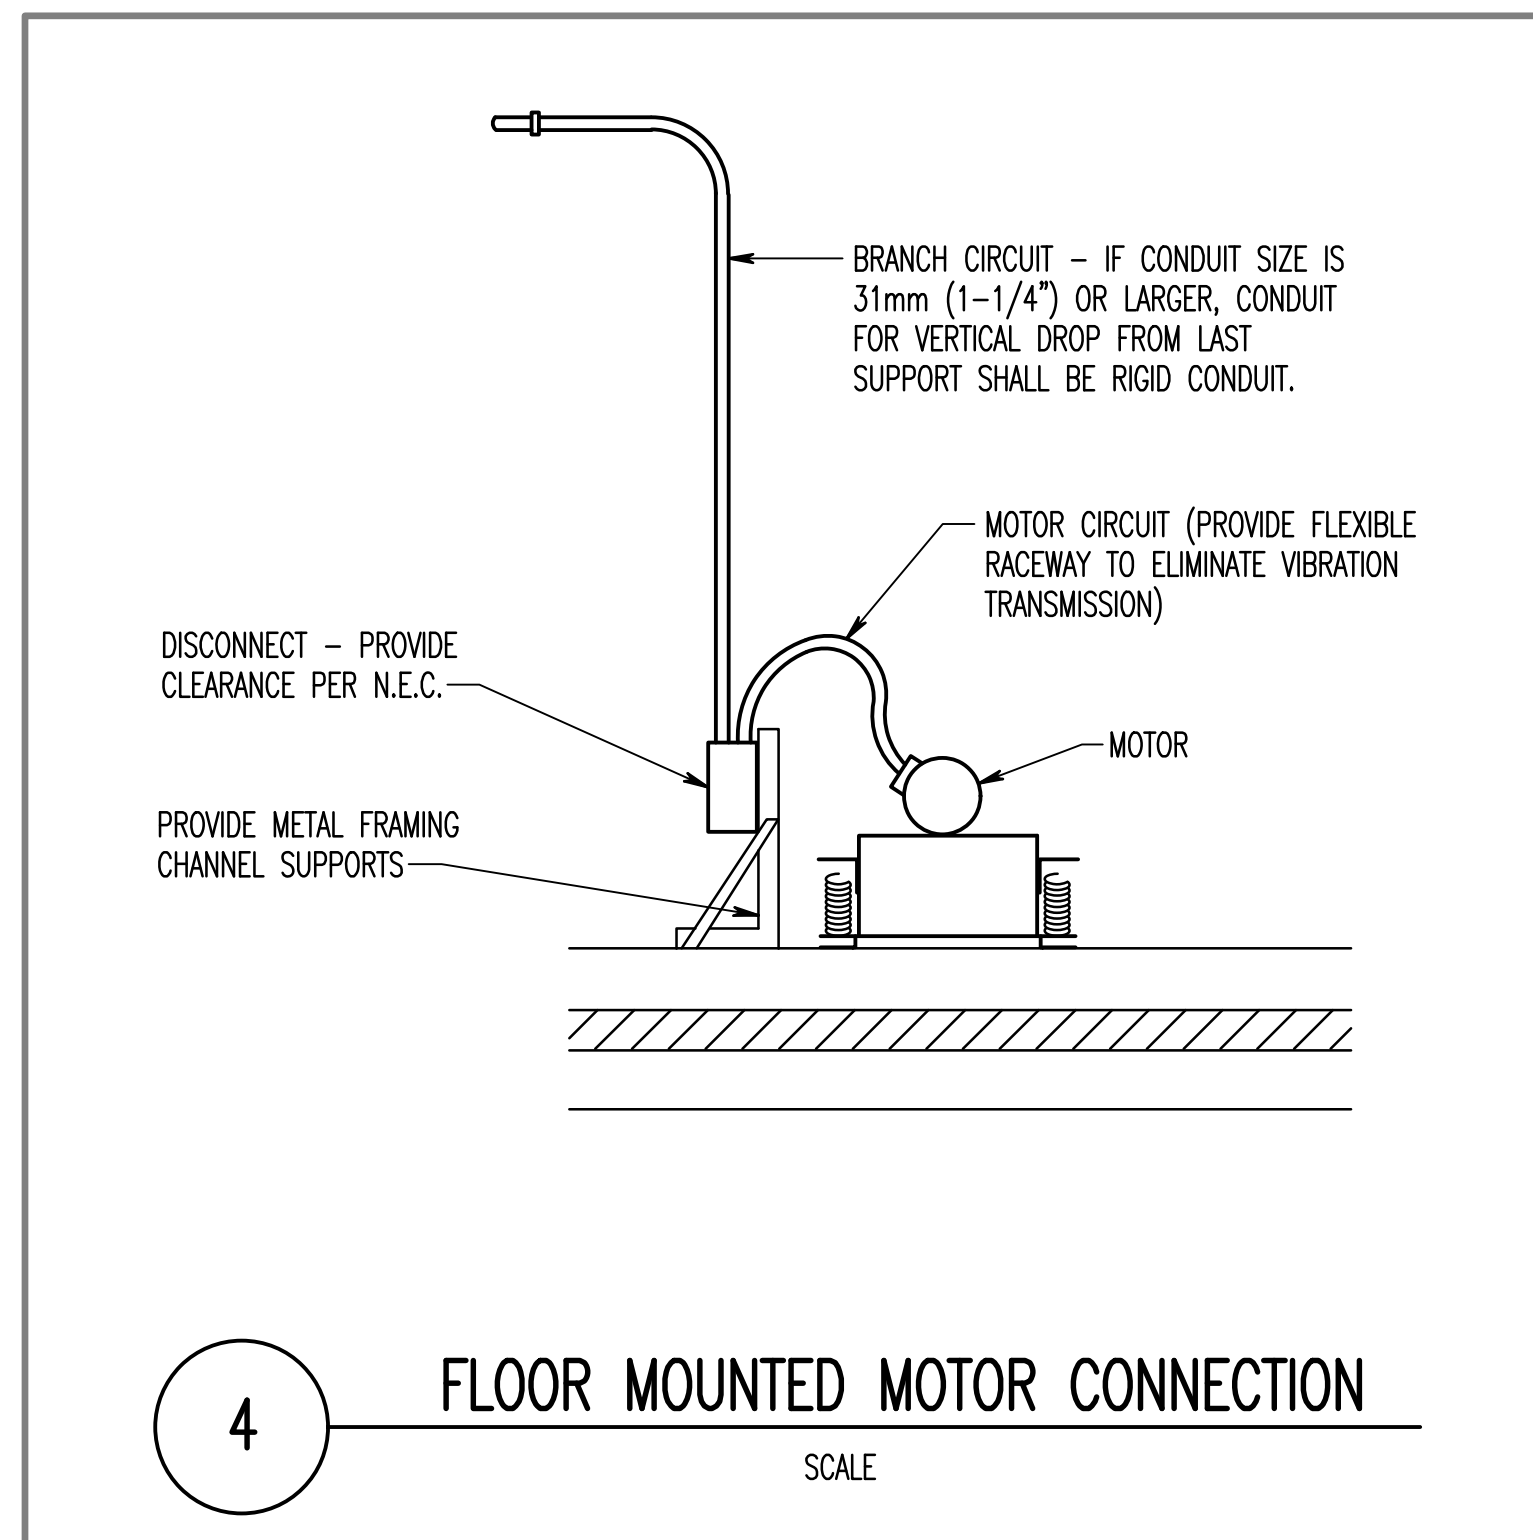
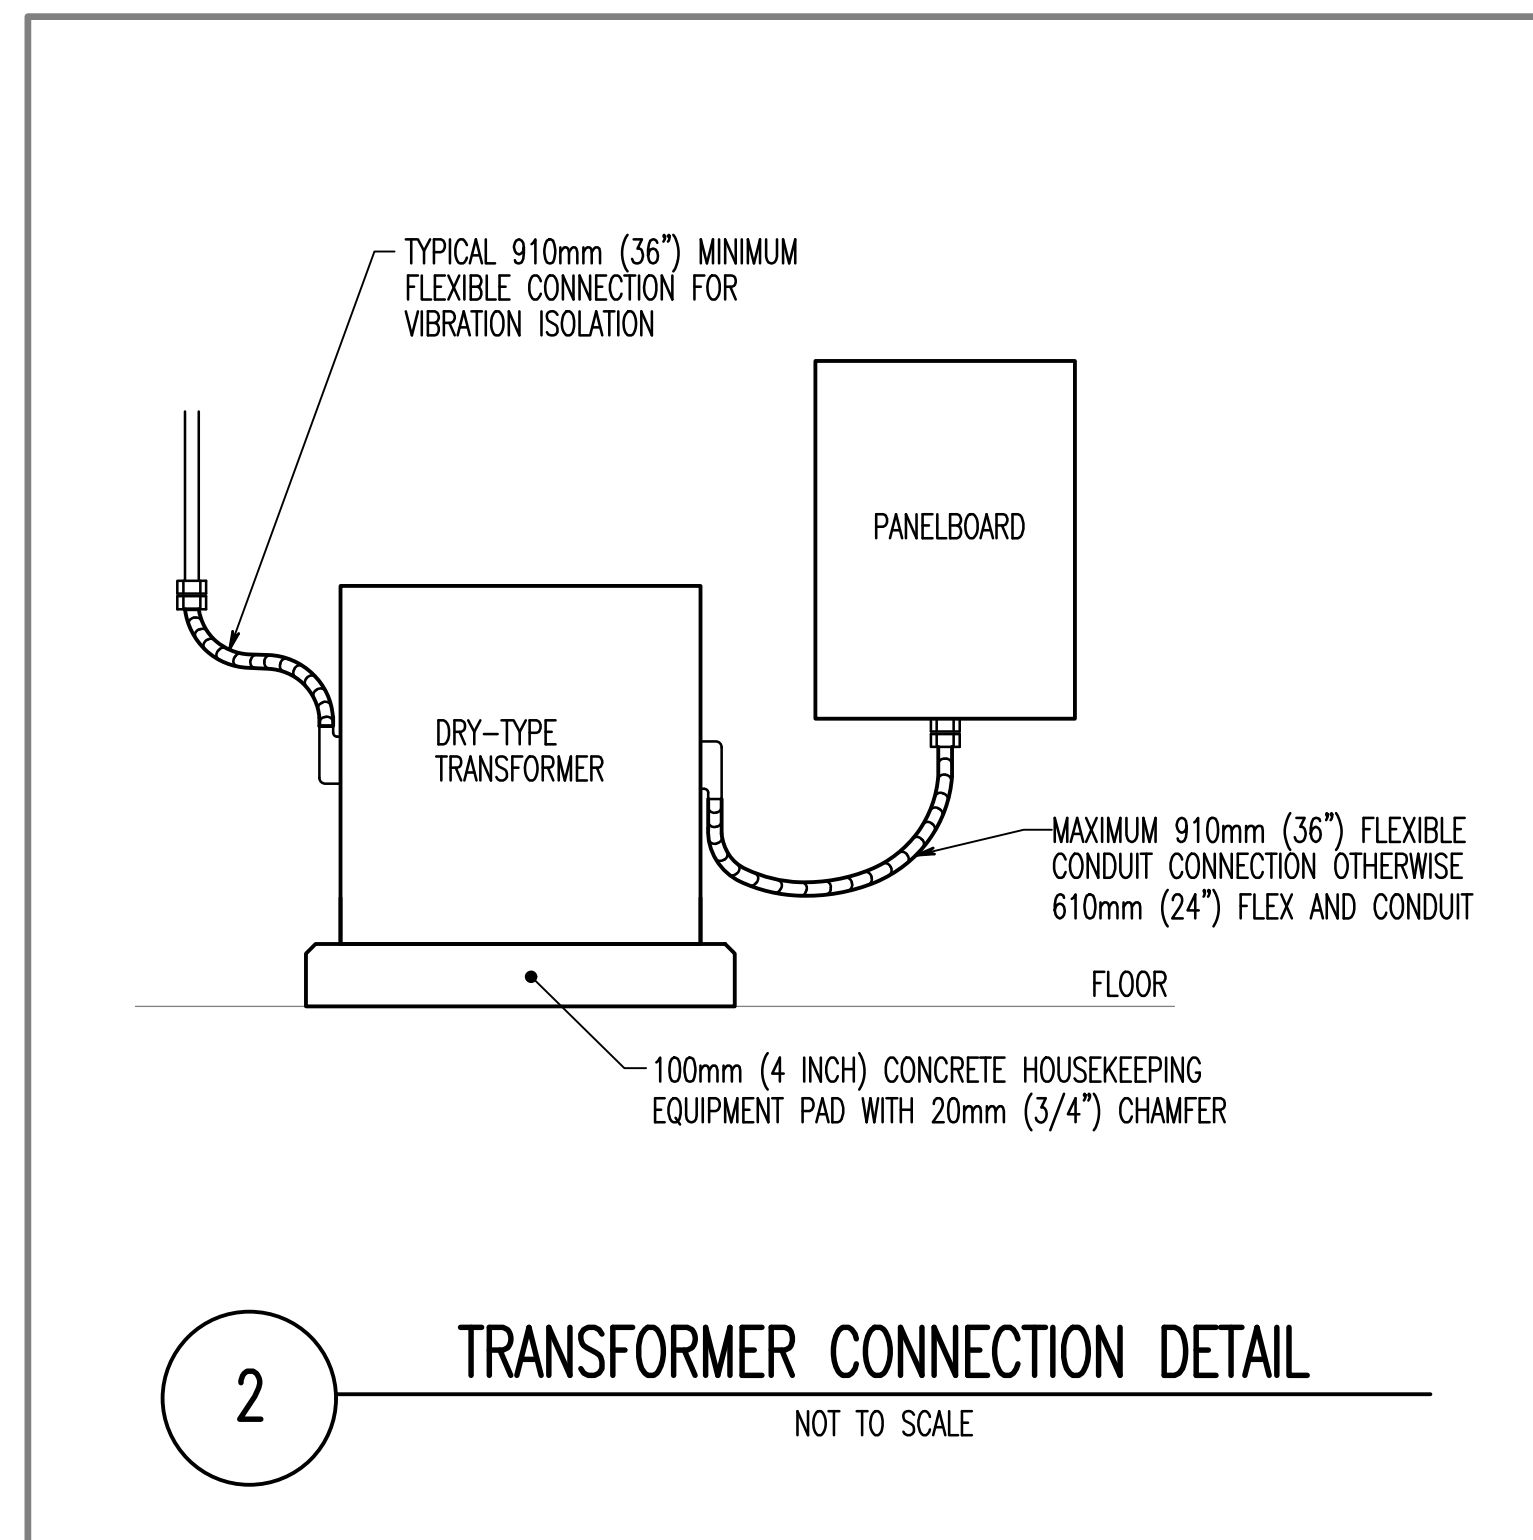
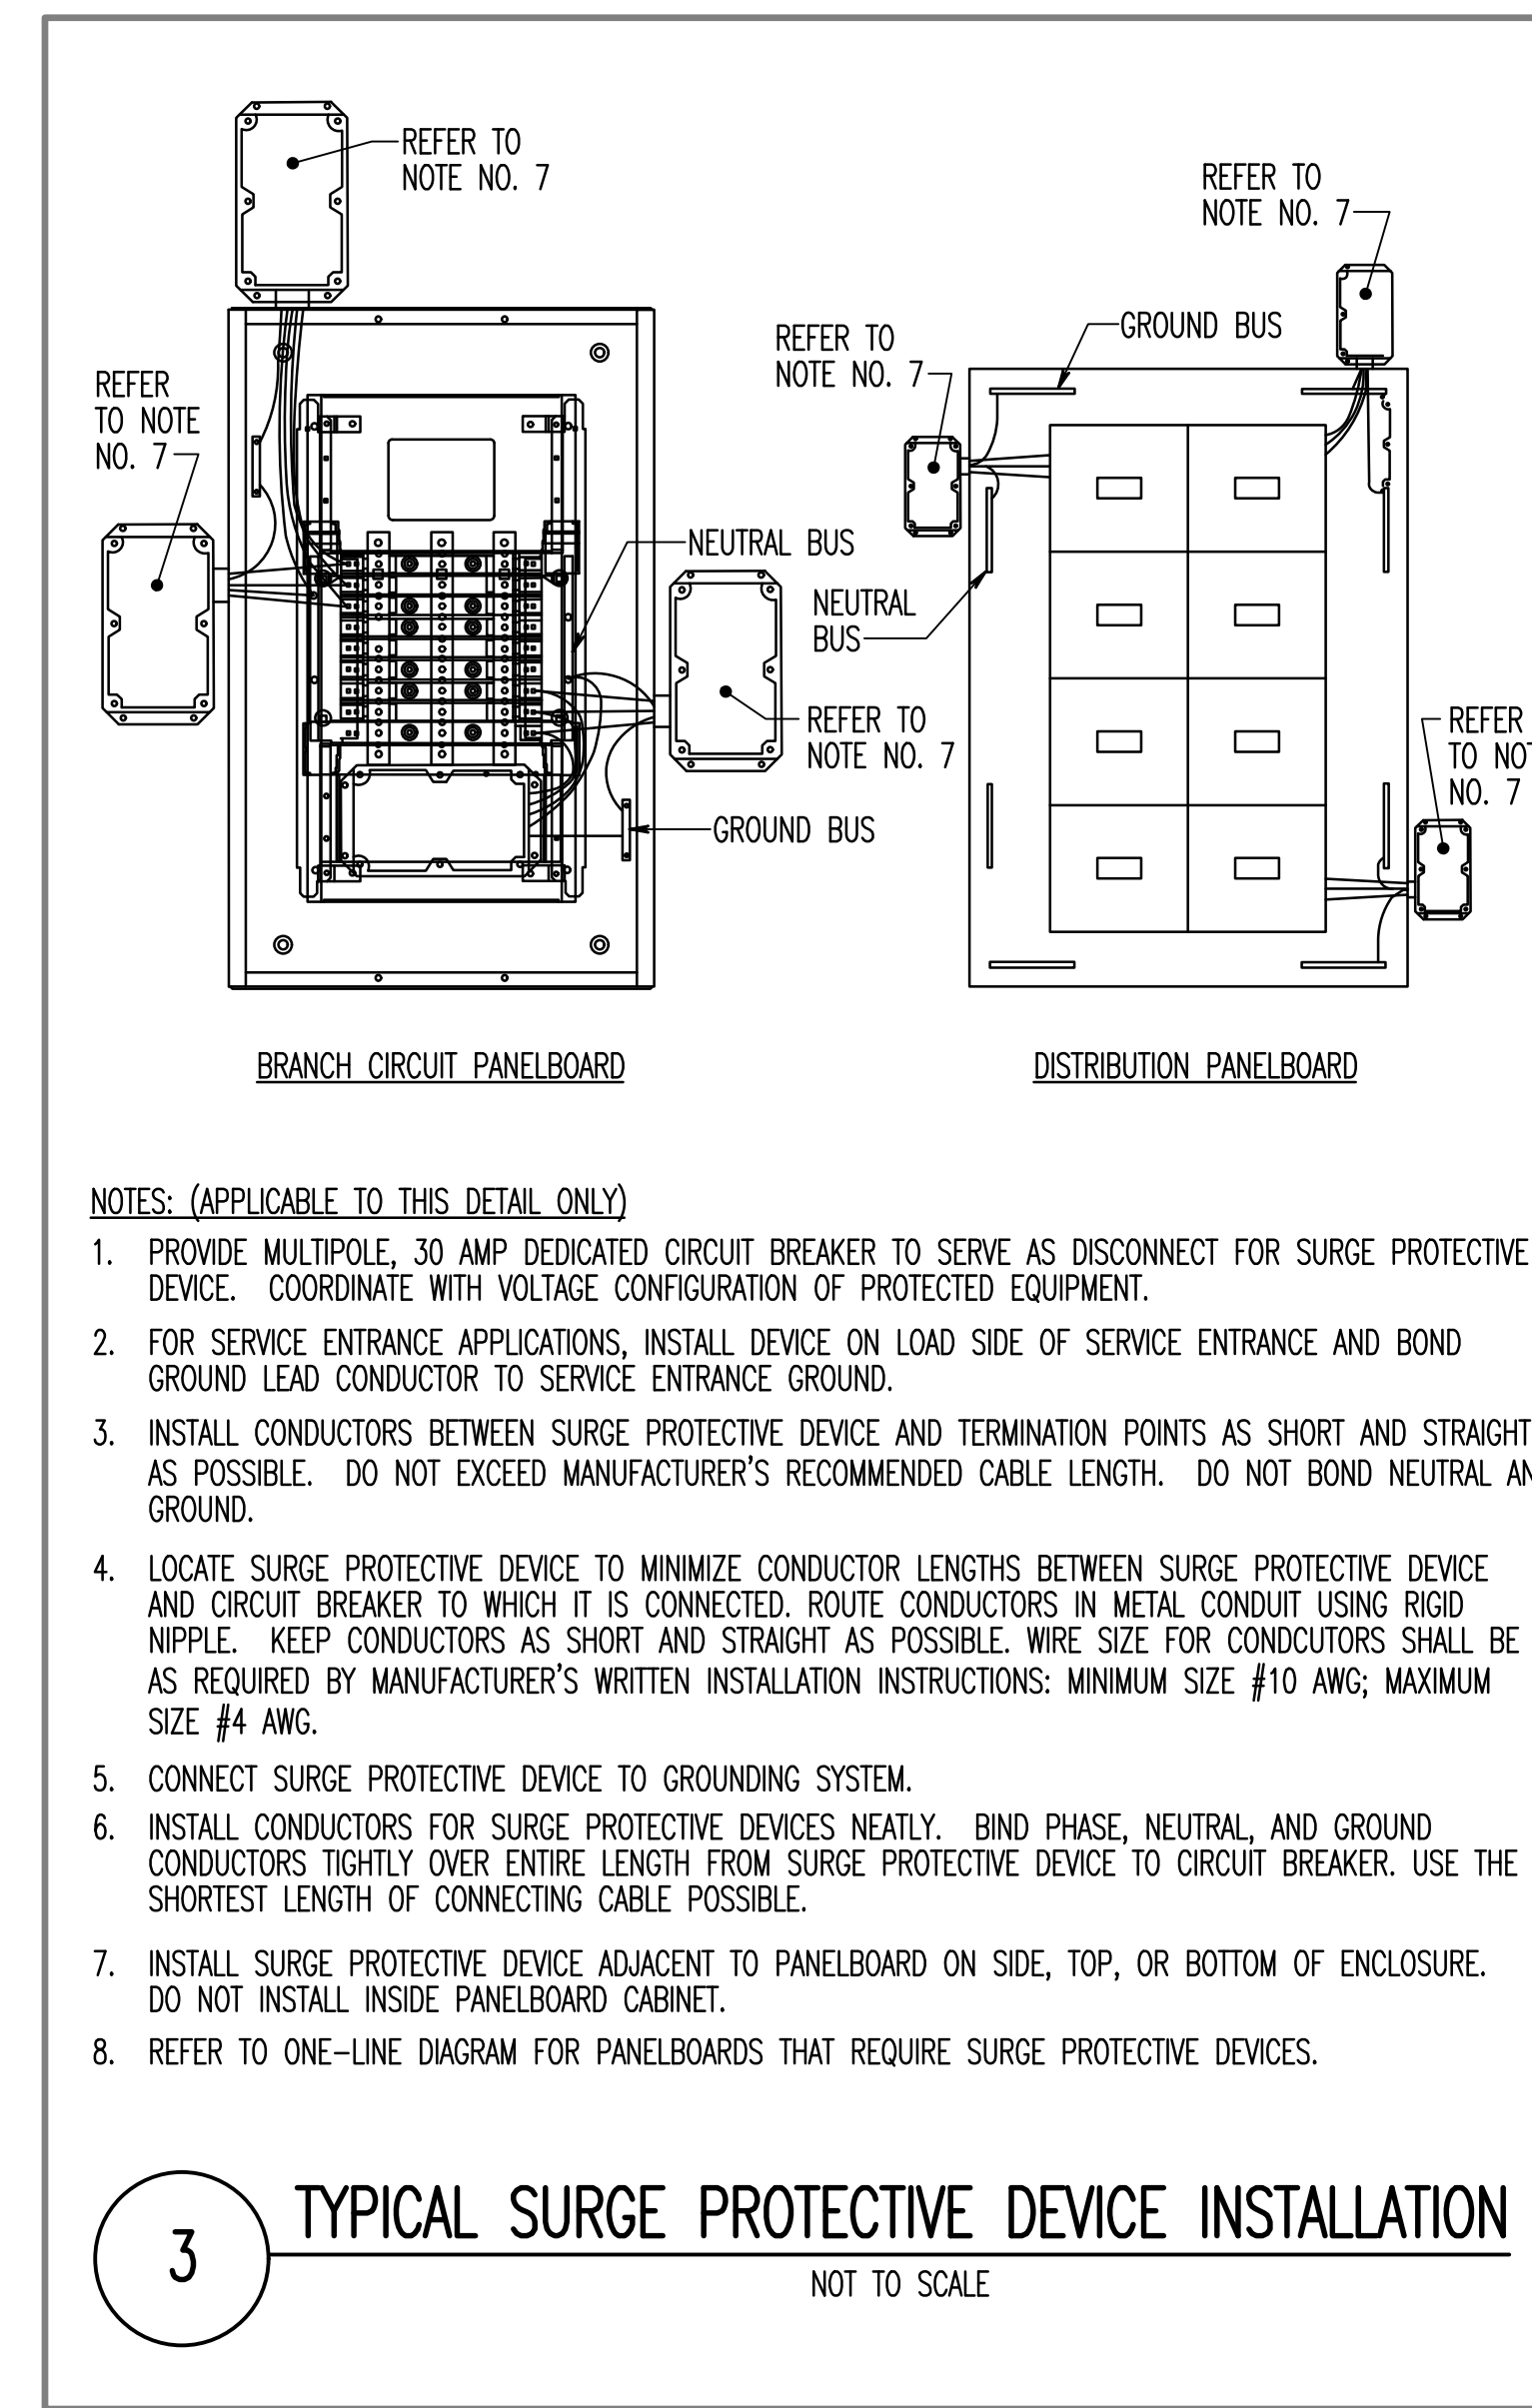
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Approved: Chief, Facilities and Engineering	
Approved: Associate Chief for Maintenance And Operations, Perry Point	
Approved: Engineering Projects Supervisor	
Approved: Infection Control Officer	

Drawing Title	ELECTRICAL GROUNDING DETAILS
Approved: Associate Director for Operations	
Approved: Director, Medical Center	

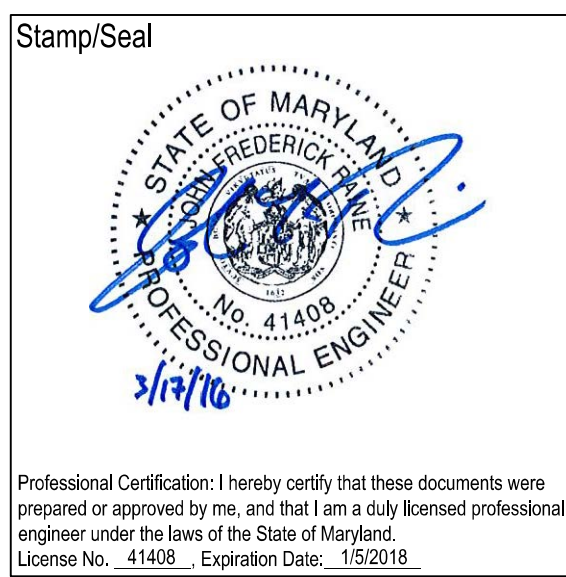FULLY SPRINKLERED			
Project Title	WAREHOUSE RENOVATION & EXPANSION		
Date	03/17/16		
VA Project Number	512-530		
Drawing Number	E502		
Scale	NONE	Building Number	360
Checked	JFR	Drawn	MLS
Location	PERRY POINT, MD		





Additions:	Date
Revisions:	Date
SCHEMATIC DESIGN (30%) SUBMISSION	03/25/15
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Stamp/Seal

STATE OF MARYLAND
 JOHN FREDERICK
 No. 41408
 PROFESSIONAL ENGINEER

3/14/16

Professional Certification: I hereby certify that these documents were prepared or approved by me, and that I am a duly licensed professional engineer under the laws of the State of Maryland.

Signature: Steven A. Smith Date: 3/14/16

	Approved:


	Approved: Chief, Facilities and Engineering
	Approved: Associate Chief for Maintenance And Operations, Perry Point
	Approved: Engineering Projects Supervisor
	Approved: Infection Control Officer

Drawing Title	ELECTRICAL DETAILS
Approved: Associate Director for Operations	
Approved: Director, Medical Center	

FULLY SPRINKLERED					Date	03/17/16
Project Title WAREHOUSE RENOVATION & EXPANSION					VA Project Number 512-530	
Scale	Building Number	Checked	Drawn	Drawing Number		
NONE	360	JFR	MLS	E503		
Location PERRY POINT, MD						






THREE INCHES= ONE FOOT (3"=1'-0")
ONE AND ONE HALF INCHES= ONE FOOT (1 1/2"=1'-0")
ONE INCH= ONE FOOT (1"=1'-0")
THREE QUARTERS INCH= ONE FOOT (3/4"=1'-0")
ONE HALF INCH= ONE FOOT (1/2"=1'-0")
THREE EIGHTHS INCH= ONE FOOT (3/8"=1'-0")
ONE QUARTER INCH= ONE FOOT (1/4"=1'-0")
ONE EIGHTH INCH= ONE FOOT (1/8"=1'-0")

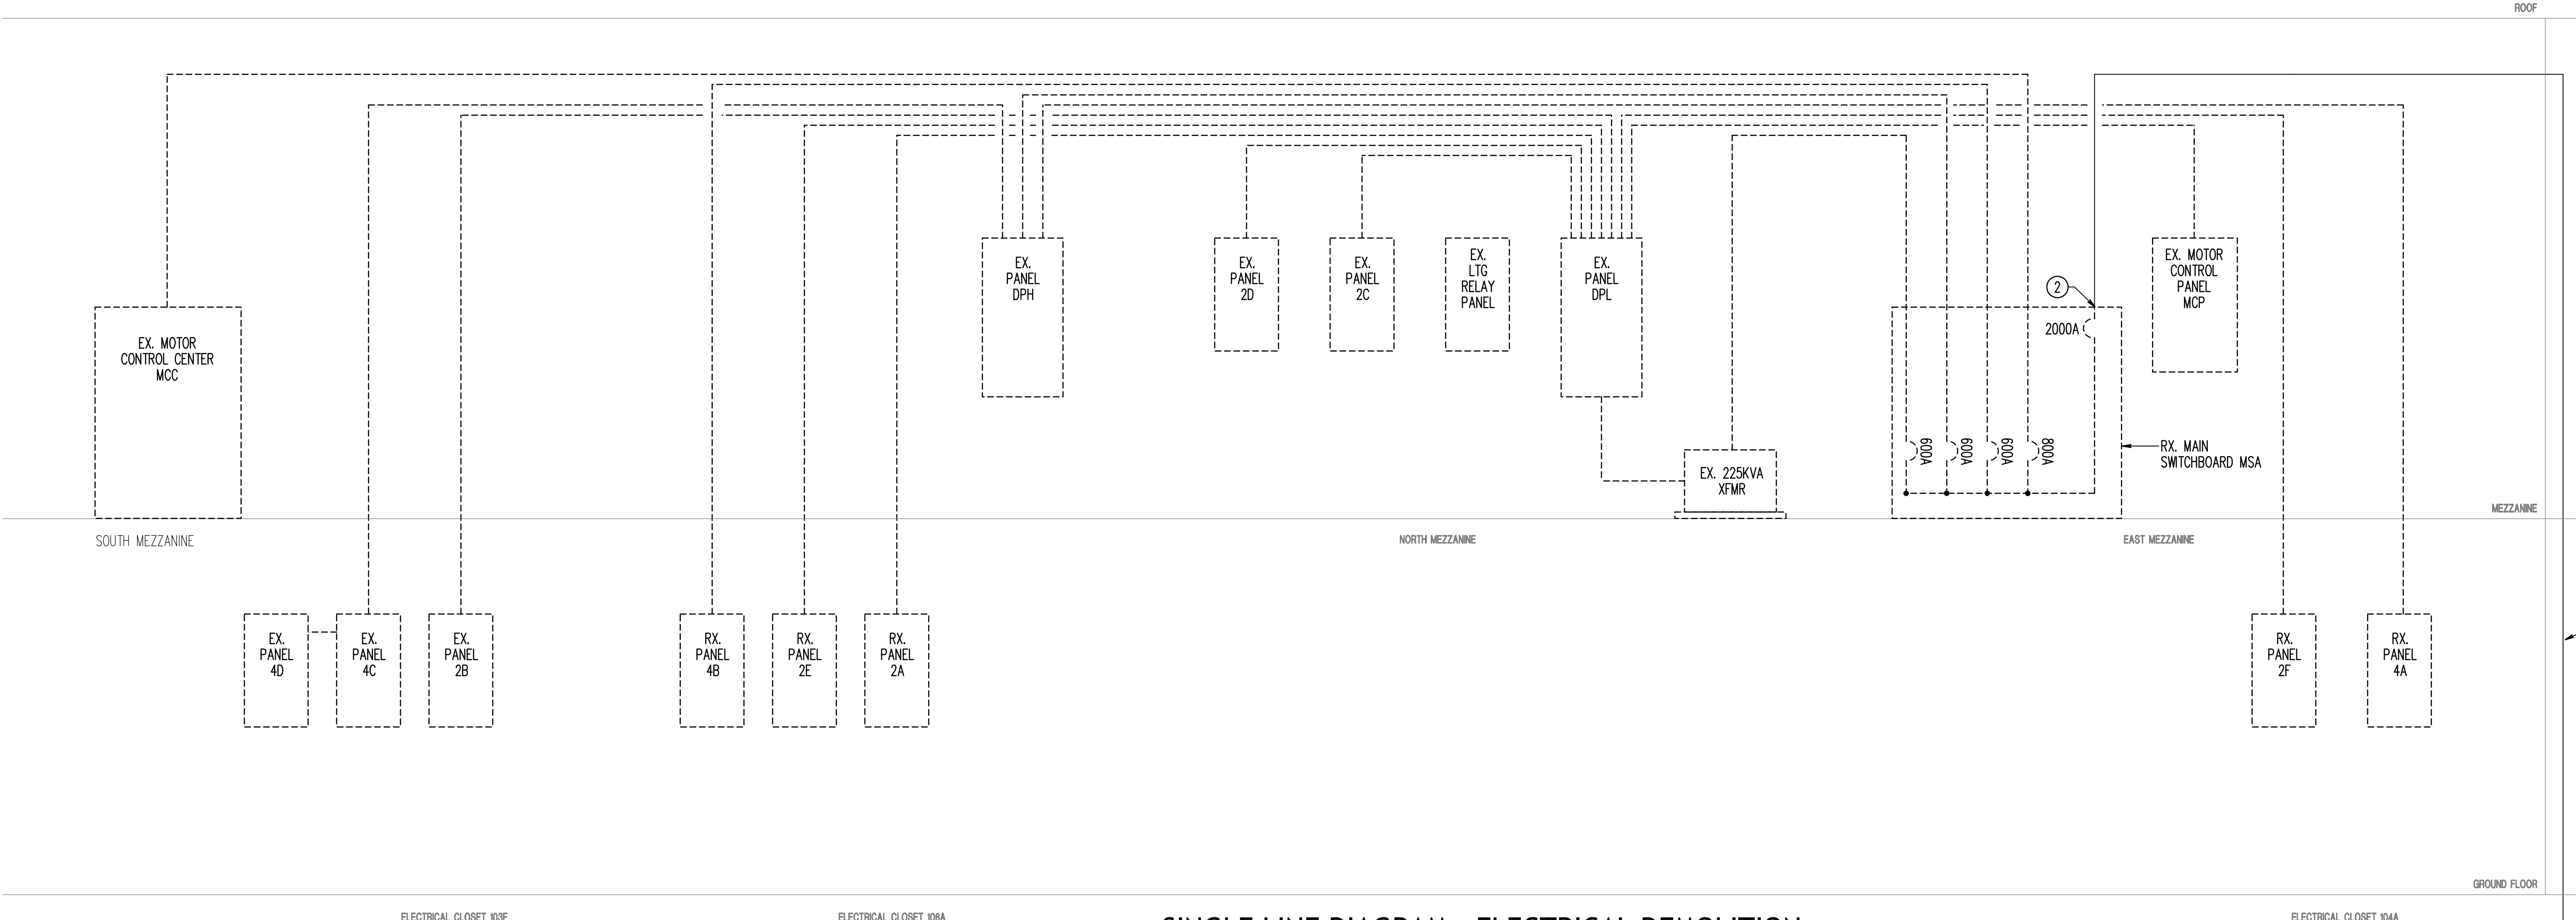

DRAWING NOTES: (APPLICABLE TO THIS SHEET ONLY)
D1. EXISTING SHOWN WITH LIGHT WEIGHT LINE,
D2. NEW WORK SHOWN WITH HEAVY WEIGHT LINE,

- SPECIAL NOTES: (APPLICABLE TO THIS SHEET ONLY)
- SEE TRANSFORMER SCHEDULE ON SHEET E-700 FOR WIRE AND CONDUIT SIZE.
 - DISCONNECT EXISTING SERVICE CONDUCTORS FROM SWITCHBOARD AND RETAIN FOR EXTENSION TO MANUAL TRANSFER SWITCH.
 - 800A ROLL UP GENERATOR CONNECTION CABINET. (BASIS OF DESIGN: EATON MODEL NO. GTB08MAMA)
 - EXTEND EXISTING SERVICE CONDUCTORS RETAINED FROM RX. SWITCHBOARD. CONNECT TO NORMAL TERMINAL OF MANUAL TRANSFER SWITCH. (5) SETS 4#500KCMIL + 1#1/0GW IN 4"C.
 - (5) SETS 4#500KCMIL + 1#1/0GW IN 4"C.
 - 3P-800A, 480V ENCLOSED CIRCUIT BREAKER FOR FIRE PUMP, SERVICE ENTRANCE, RATED. PROVIDE PLACARD INDICATING "FIRE PUMP DISCONNECTING MEANS"
 - 3#1/0 + 1#6GW TYPE MI CABLE

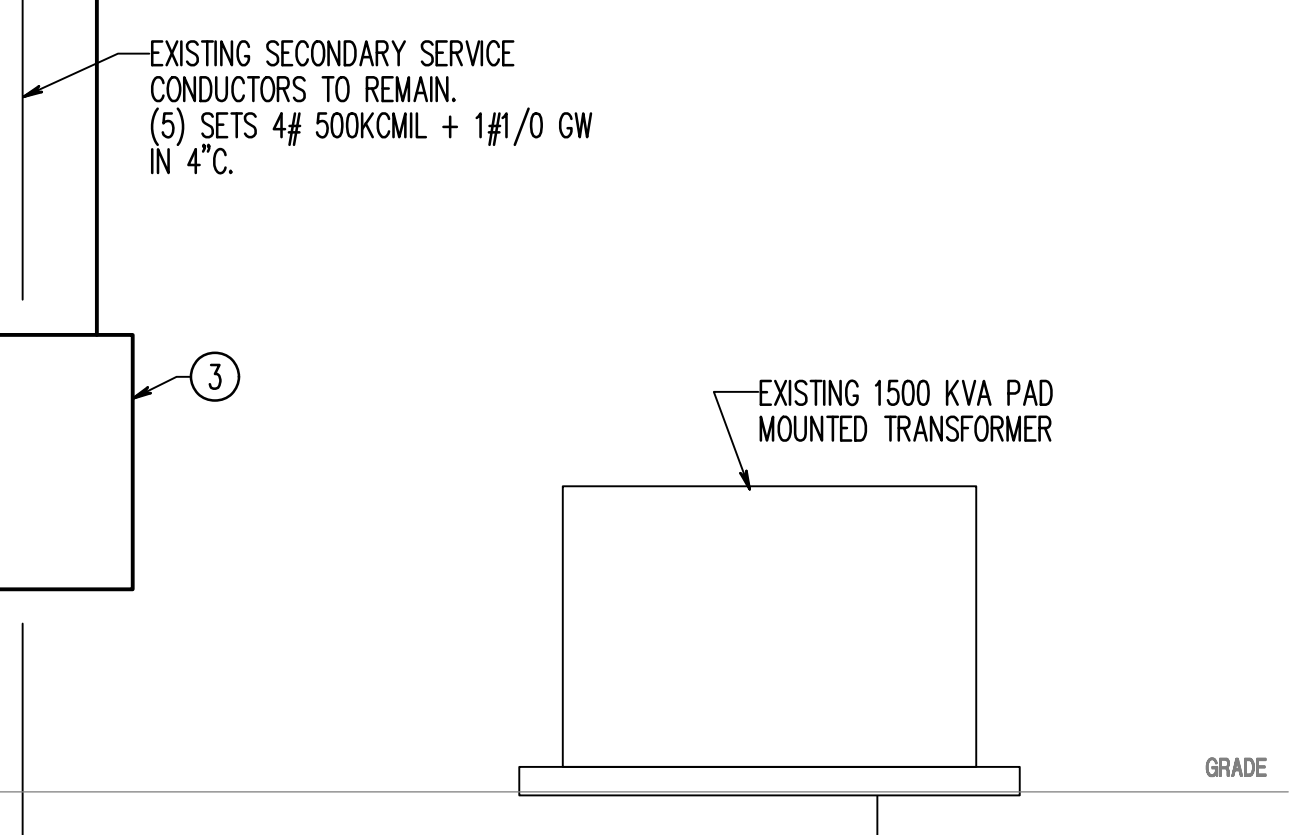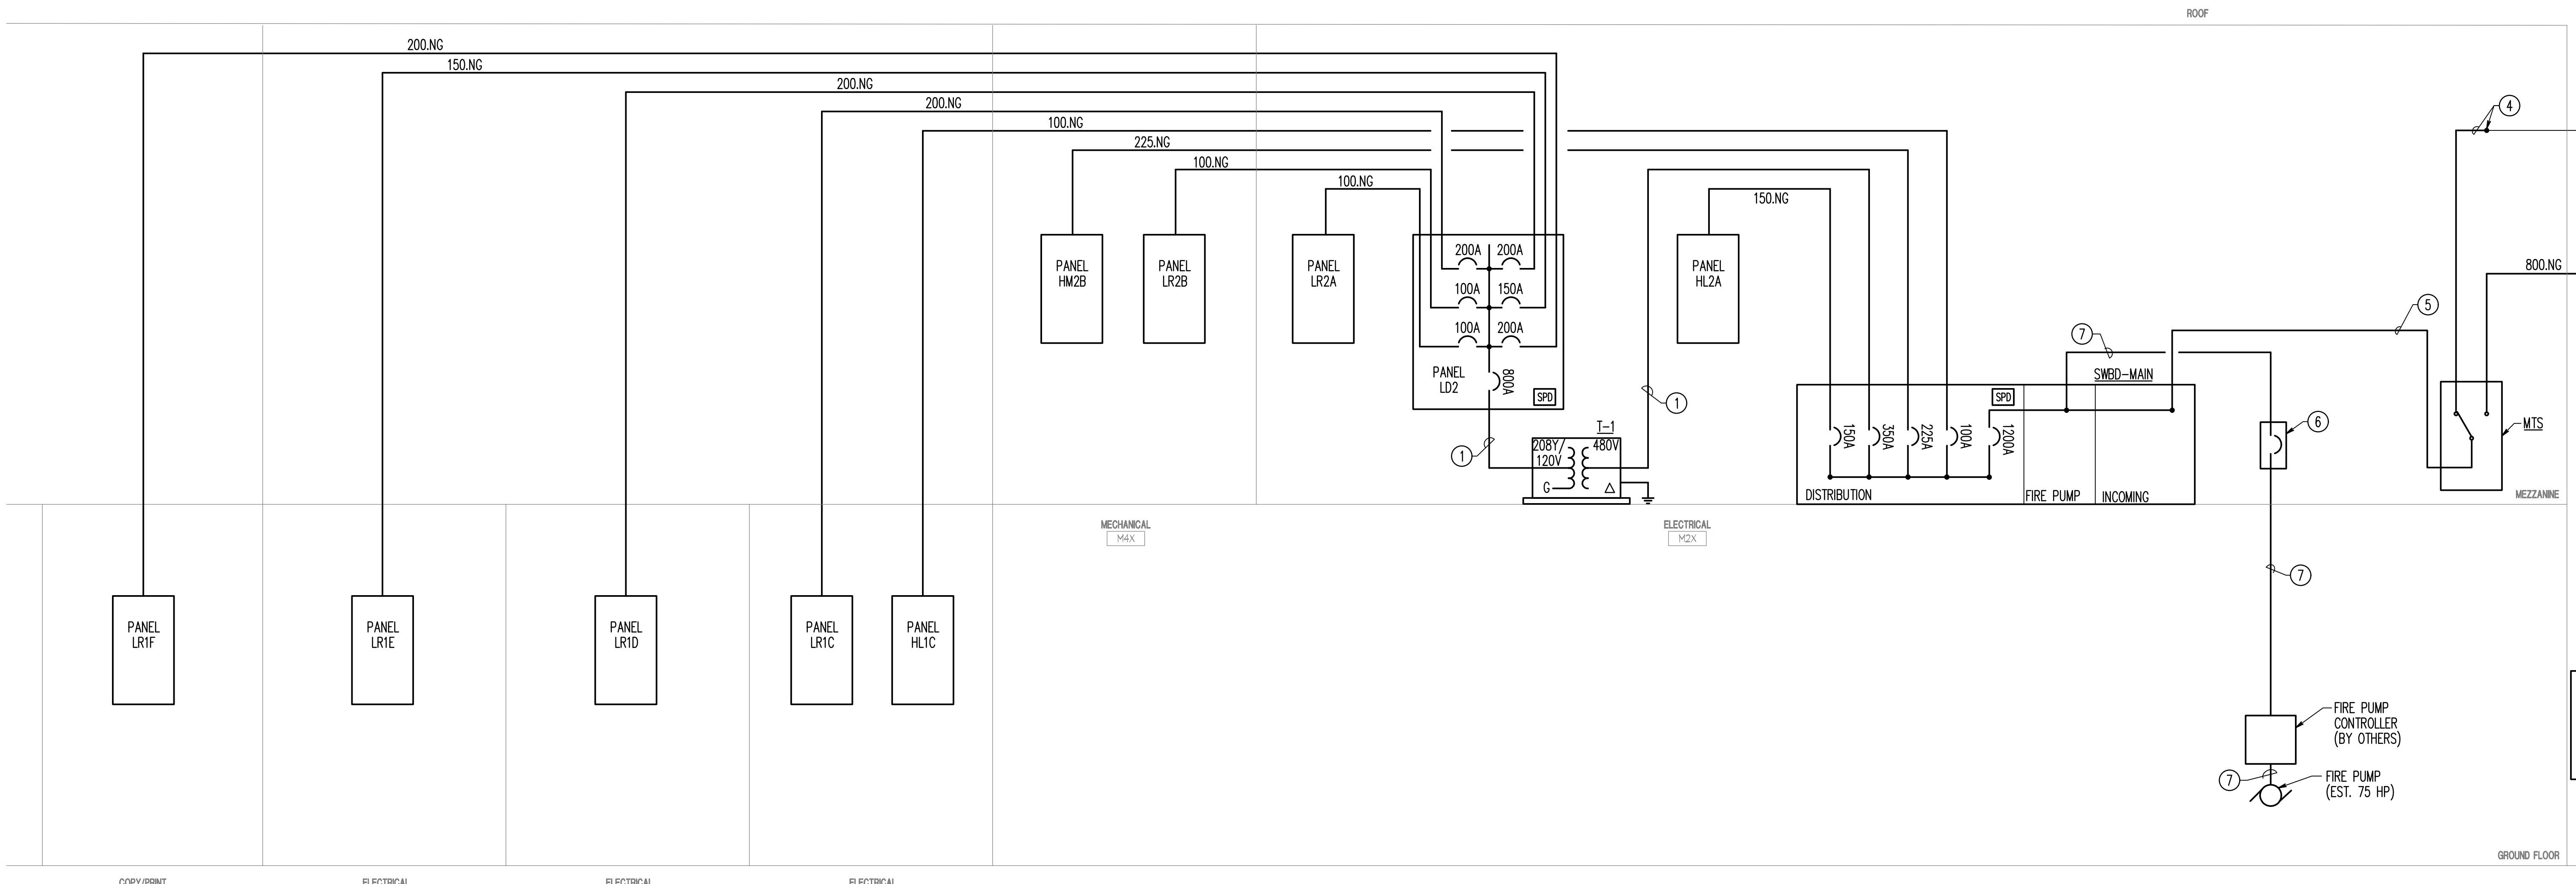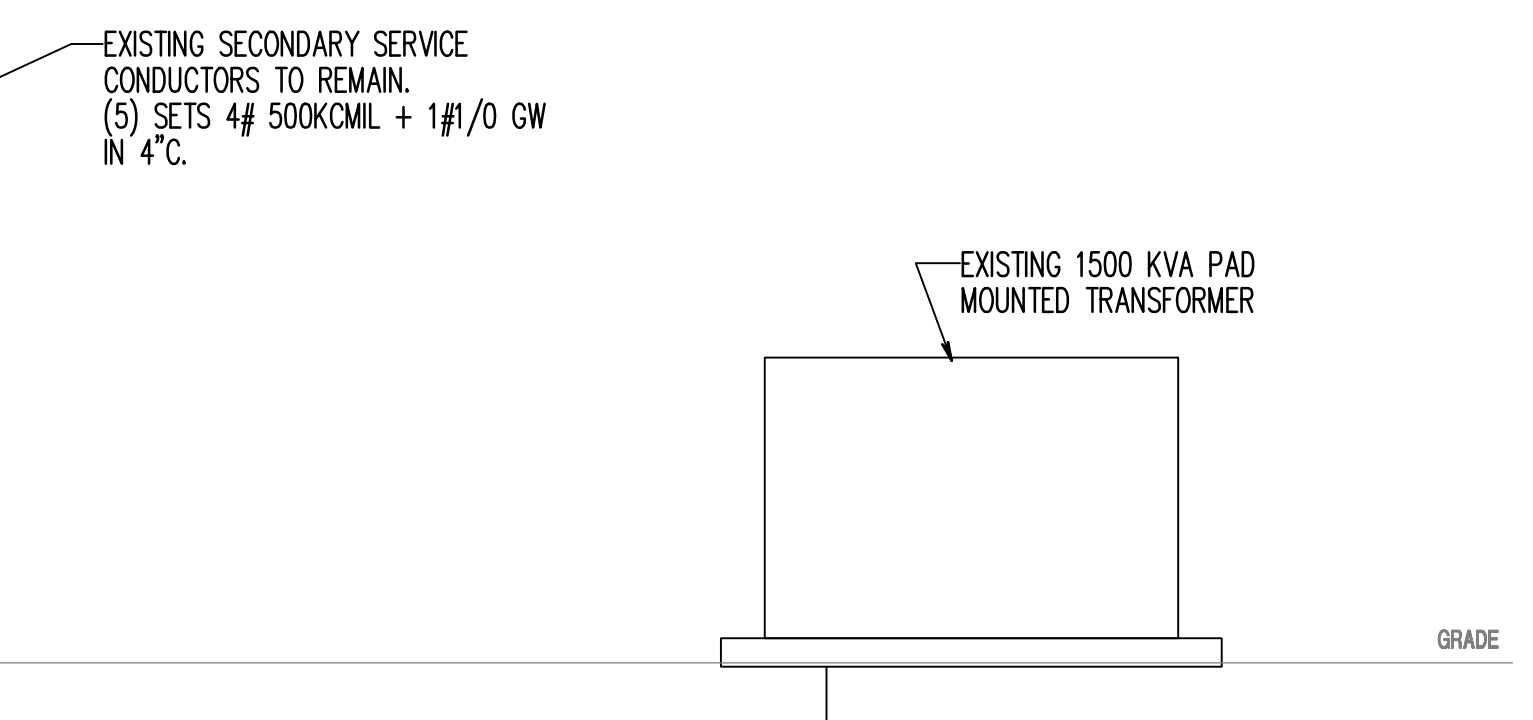

Additions:		Date:	
Revisions:		Date:	
SCHEMATIC DESIGN (30%) SUBMISSION		03/25/15	
DESIGN DEVELOPMENT (60%) SUBMISSION		09/11/15	
CONSTRUCTION DOCUMENTS (90%) SUBMISSION		11/23/15	
BID DOCUMENTS		03/17/16	


ARCHITECT / ENGINEERS / CONSULTANTS:			
OKKS Studios, Inc. 2 Wisconsin Circle / Suite 820 Chevy Chase, MD 20815-7003 Tel: (301) 718-0080 Fax: (301) 718-9520 www.okksstudios.com		Woods Peacock Engineering Consultants 5250 Cherokee Avenue, Suite 420 Alexandria, VA 22312-2052 Tel: (703) 658-4400 Fax: (703) 658-4404	
Nobis Engineering, Inc. 20410 Century Boulevard, Suite 230 Germantown, MD 20874 Tel: (301) 528 2010		The Protection Engineering Group 2809 Boston Street, Suite 7 Baltimore, MD 21224 USA Tel: (443) 708-4096 Fax:	
Henry Adams Consulting Engineers, LLC. 600 Baltimore Ave, 4th Floor Baltimore, MD 21204 Tel: (410) 296-6500 Fax: (410) 296-6501			

Stamp/Seal	Approved:	Approved: Chief, Facilities and Engineering	Drawing Title
			ELECTRICAL SINGLE LINE DIAGRAMS
Professional Certification: I hereby certify that these documents were prepared or approved by me, and that I am a duly licensed professional engineer under the laws of the State of Maryland. License No.: 41408, Expiration Date: 11/30/18		Approved: Associate Chief for Maintenance And Operations, Perry Point	Approved: Associate Director for Operations
		Approved: Engineering Projects Supervisor	Approved: Director, Medical Center
		Approved: Infection Control Officer	

FULLY SPRINKLERED			
Project Title			
WAREHOUSE RENOVATION & EXPANSION			
Scale	Building Number	Checked	Drawn
NONE	360	JFR	MLS
Location			
PERRY POINT, MD			
Date		03/17/16	
VA Project Number		512-530	
Drawing Number		E600	

DEPARTMENT OF VETERANS AFFAIRS

THREE INCHES - ONE FOOT (3" = 1'-0")
ONE AND ONE HALF INCHES - ONE FOOT (1 1/2" = 1'-0")
ONE INCH - ONE FOOT (1" = 1'-0")
THREE QUARTERS INCH - ONE FOOT (3/4" = 1'-0")
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ONE QUARTER INCH - ONE FOOT (1/4" = 1'-0")
ONE EIGHT INCH - ONE FOOT (1/8" = 1'-0")

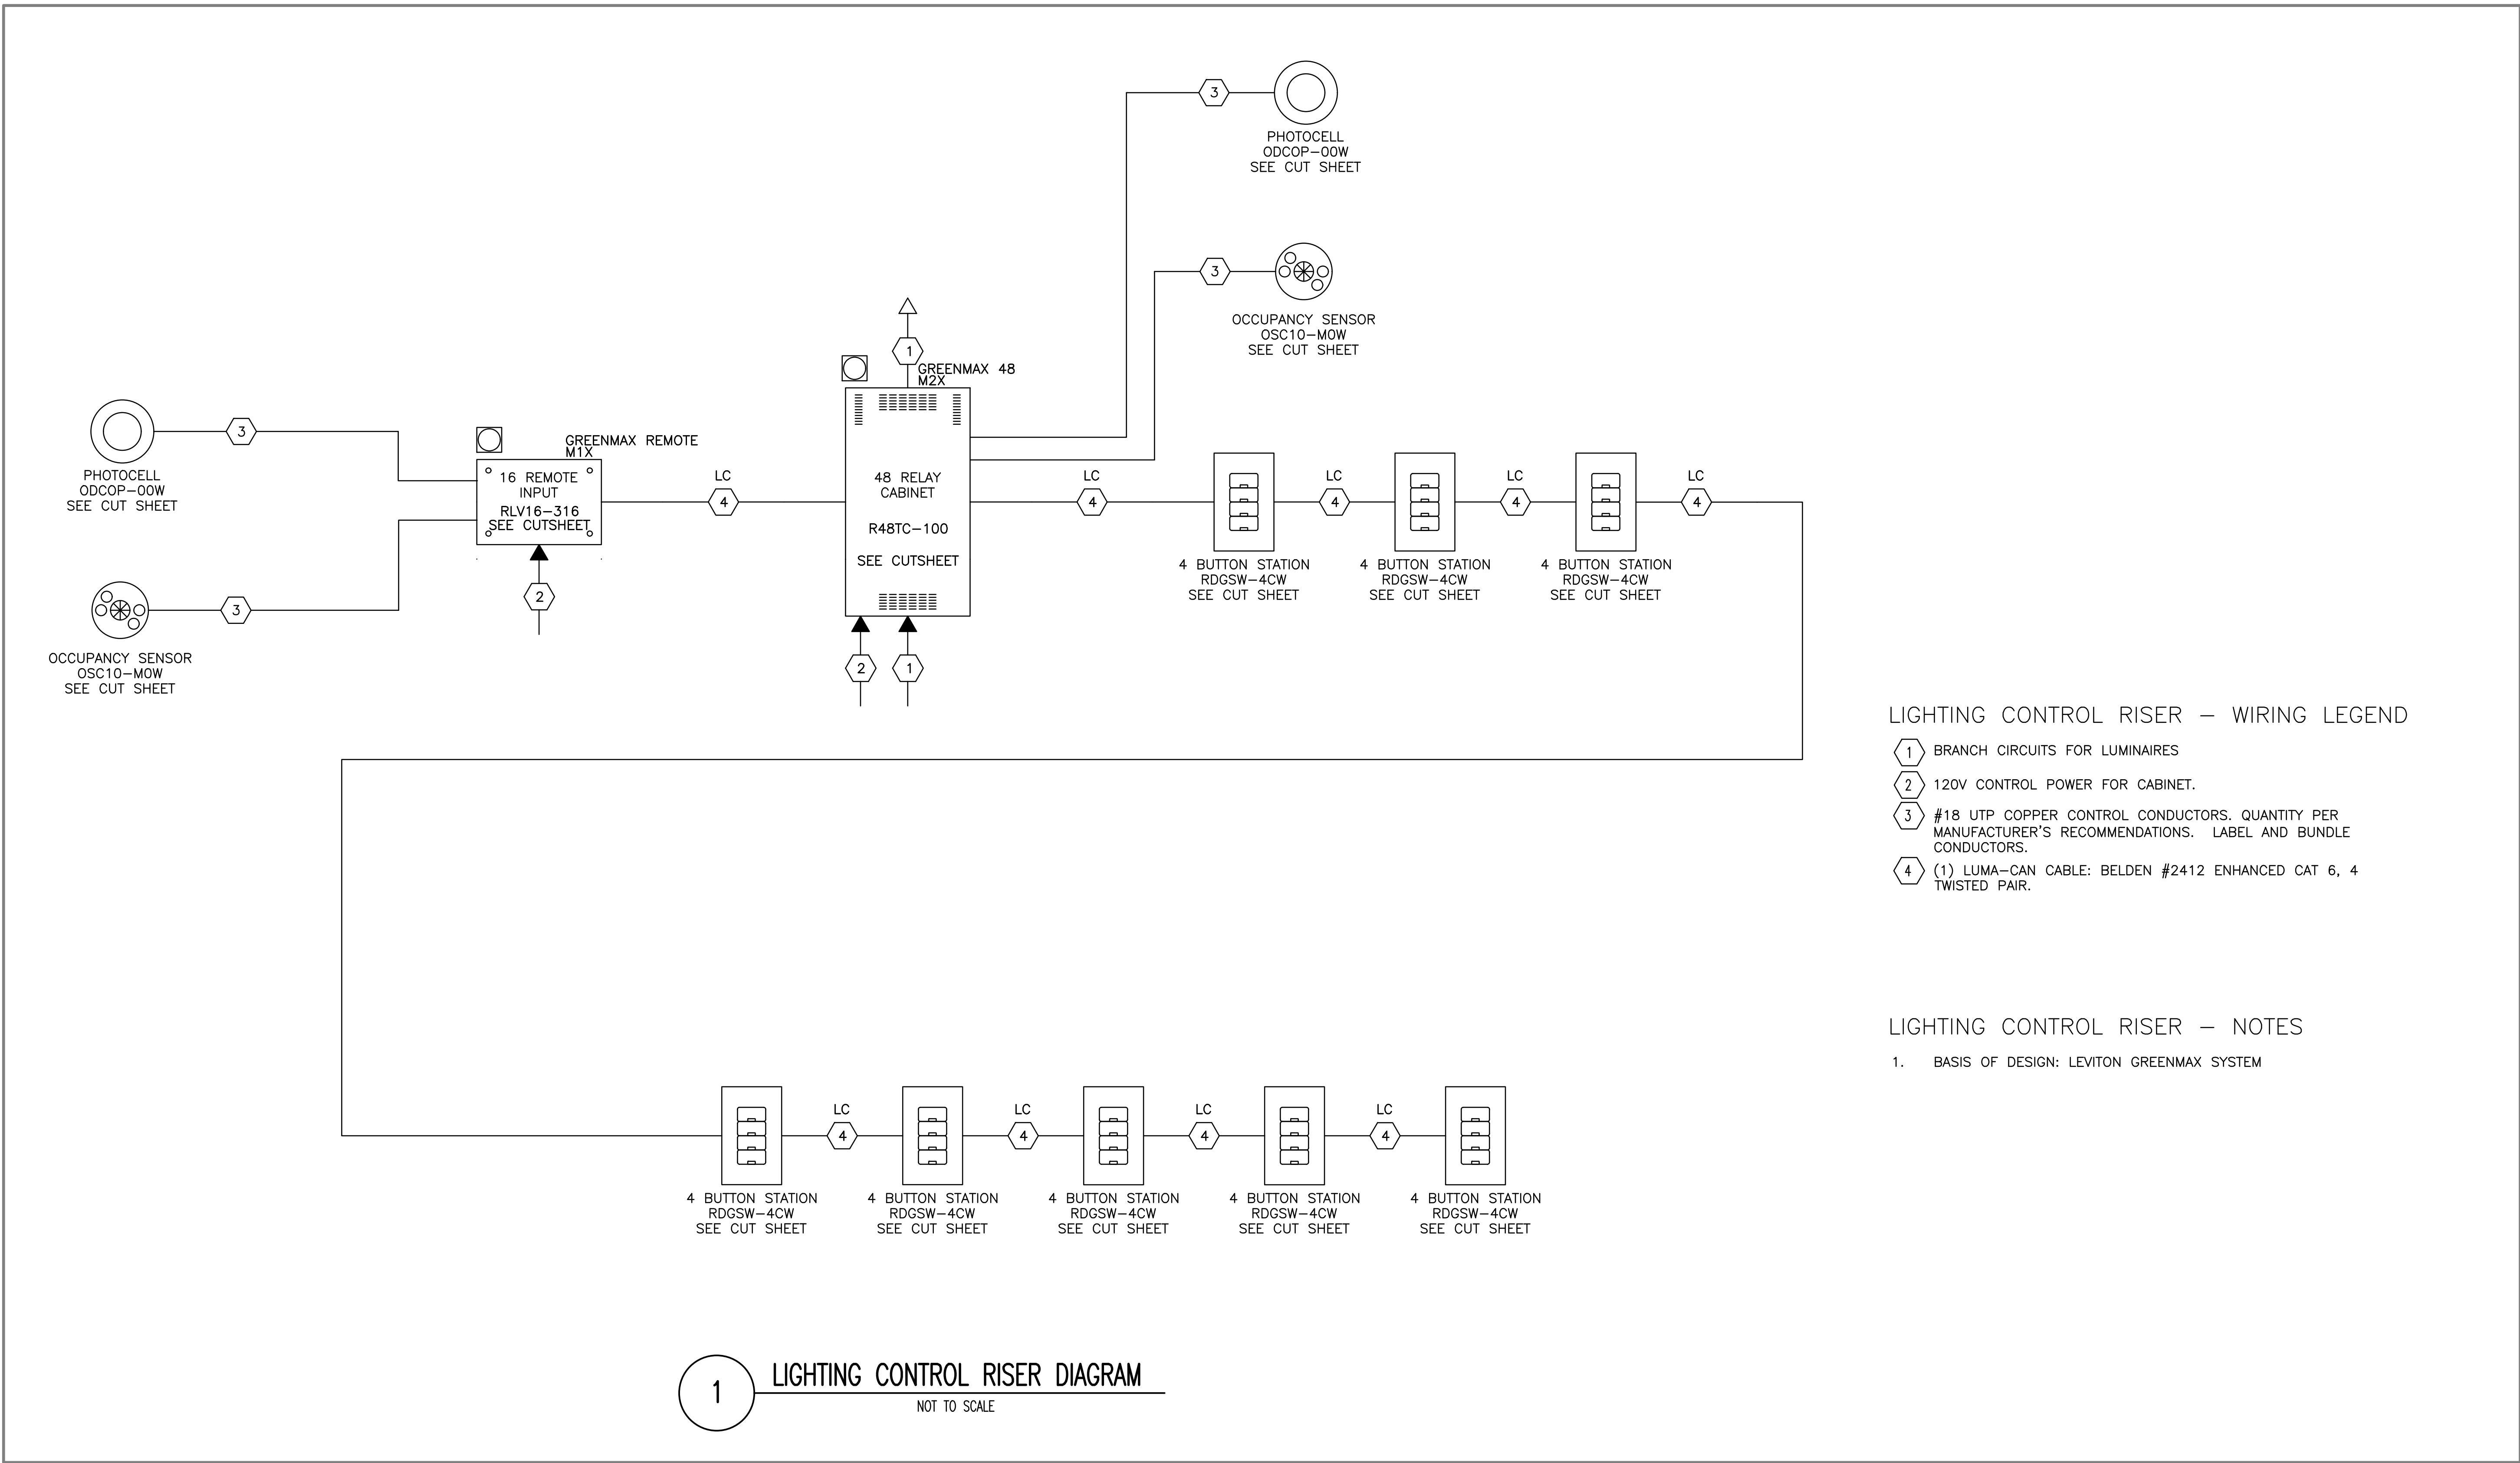

LIGHTING CONTROL RISER - WIRING LEGEND

- 1 BRANCH CIRCUITS FOR LUMINAIRES
- 2 120V CONTROL POWER FOR CABINET.
- 3 #18 UTP COPPER CONTROL CONDUCTORS. QUANTITY PER MANUFACTURER'S RECOMMENDATIONS. LABEL AND BUNDLE CONDUCTORS.
- 4 (1) LUMA-CAN CABLE: BELDEN #2412 ENHANCED CAT 6, 4 TWISTED PAIR.

LIGHTING CONTROL RISER - NOTES

- 1. BASIS OF DESIGN: LEVITON GREENMAX SYSTEM

Additions:	Date
Revisions:	Date
SCHEMATIC DESIGN (30%) SUBMISSION	03/25/15
DESIGN DEVELOPMENT (60%) SUBMISSION	09/11/15
CONSTRUCTION DOCUMENTS (90% SUBMISSION)	11/23/15
BID DOCUMENTS	03/17/16

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Fax: (703) 658-4404

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2809 Boston Street, Suite 7
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Fax:

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Approved:

Approved: Chief, Facilities and Engineering
Approved: Associate Chief for Maintenance And Operations, Perry Point
Approved: Engineering Projects Supervisor
Approved: Infection Control Officer

Drawing Title
LIGHTING CONTROL RISER DIAGRAM AND SCHEDULES
Approved: Associate Director for Operations
Approved: Director, Medical Center

FULLY SPRINKLERED

Project Title
WAREHOUSE RENOVATION & EXPANSION
Scale
NONE
Building Number
360
Checked
JFR
Drawn
MLS
Location
PERRY POINT, MD

Date
03/17/16
VA Project Number
512-530
Drawing Number
E601



LUMINAIRE SCHEDULE													
TYPE	MOUNTING	LUMINAIRE DESCRIPTION	MANUFACTURER	CATALOG NUMBER	TYPE	LAMP				DRIVER/BALLAST			NOTES
						CRI	CCT	QTY	WATTS/ LAMP	LUMENS/ LAMP	TYPE	QTY	
A	RECESSED	2'X4' LENSED TROFFER WITH A19 PATTERN LENS, FLUSH WHITE ALUMINUM DOOR	LITHONIA	2TL4-48L-FW-A19-SLD-LP835	L.E.D.	-	3500	1	40W	4800	0-10V DRIVER	1	-
A1	RECESSED	2'X4' LENSED TROFFER WITH A19 PATTERN LENS, FLUSH WHITE ALUMINUM DOOR, EMERGENCY BATTERY PACK	LITHONIA	2TL4-48L-FW-A19-SLD-LP835-EL14L	L.E.D.	-	3500	1	40W	4800	0-10V DRIVER	1	-
B	RECESSED	2'X2' LENSED TROFFER WITH A19 PATTERN LENS, FLUSH WHITE ALUMINUM DOOR	LITHONIA	2TL4-33L-FW-A19-SLD-LP835	L.E.D.	-	3500	1	29W	3300	0-10V DRIVER	1	-
B1	RECESSED	2'X2' LENSED TROFFER WITH A19 PATTERN LENS, FLUSH WHITE ALUMINUM DOOR, EMERGENCY BATTERY PACK	LITHONIA	2TL4-33L-FW-A19-SLD-LP835-EL14L	L.E.D.	-	3500	1	29W	3300	0-10V DRIVER	1	-
C	SUSPENDED	8" HIGH BAY STRIP FIXTURE WITH NARROW AREA DISTRIBUTION, EXTRUDED 6063-T5 ALUMINUM HOUSING AND ACRYLIC LENS, TEXTURED DARK GRAY JOINER FINISH	LITHONIA	PTNSL8-ND-OSR-LP841	L.E.D.	83	4100	1	92W	7200	0-10V DRIVER	1	-
C1	SUSPENDED	4" HIGH BAY STRIP FIXTURE WITH NARROW AREA DISTRIBUTION, EXTRUDED 6063-T5 ALUMINUM HOUSING AND ACRYLIC LENS, TEXTURED DARK GRAY JOINER FINISH, EMERGENCY BATTERY PACK	LITHONIA	PTNSL4-ND-OSR-LP841-11207	L.E.D.	83	4100	1	47W	3600	0-10V DRIVER	1	-
D	SUSPENDED 108" AFF	4' ENCLOSED AND GASKETED INDUSTRIAL FIXTURE WITH CLEAR, DEEP FROSTED ACRYLIC LENS	LITHONIA	FEM4LED-4L-IMAFD	L.E.D.	65	4100	1	61W	4728	0-10V DRIVER	1	-
F	RECESSED	2'X4' VOLUMETRIC FIXTURE WITH ACRYLIC LINEAR PRISMATIC DISFUSER	LITHONIA	2VTL4-48L-ADP-SLD-LP835	L.E.D.	82	3500	1	47W	4800	0-10V DRIVER	1	-
F1	RECESSED	2'X4' VOLUMETRIC FIXTURE WITH ACRYLIC LINEAR PRISMATIC DISFUSER, EMERGENCY BATTERY PACK	LITHONIA	2VTL4-48L-ADP-SLD-LP835-EL14L	L.E.D.	82	3500	1	47W	4800	0-10V DRIVER	1	-
G	RECESSED	2'X2' VOLUMETRIC FIXTURE WITH ACRYLIC LINEAR PRISMATIC DISFUSER	LITHONIA	2VTL2-33L-ADP-SLD-LP835	L.E.D.	82	3500	1	34.5W	3300	0-10V DRIVER	1	-
H	SUSPENDED 96" AFF	4' LENSED STRIP FIXTURE	LITHONIA	ZL1N-L48-5000LM-FST-MVOLT-35-80CRI-WH	L.E.D.	80	3500	1	38W	5000	0-10V DRIVER	1	-
H1	SURFACE	4' LENSED STRIP FIXTURE, EMERGENCY BATTERY PACK	LITHONIA	ZL1N-L48-5000LM-FST-MVOLT-35-80CRI-E7W-WH	L.E.D.	80	3500	1	38W	5000	0-10V DRIVER	1	-
K	WALL SURFACE	4' LENSED STRIP FIXTURE WITH 0-10V DRIVER AND INTEGRAL OCCUPANCY SENSOR, EMERGENCY BATTERY PACK	LITHONIA	WL4-30L-EZ1-LP835-N100-NESP07	L.E.D.	80	3500	1	28.2W	3000	0-10V DRIVER	1	-
M	WALL SURFACE	EXTERIOR WALL LUMINAIRE WITH DIE-CAST ALUMINUM HOUSING AND TEMPERED GLASS LENS, EMERGENCY BATTERY PACK, TEXTURED DARK BRONZE FINISH	LITHONIA	TWHLED-30C-1000-50K-T3M-277V-DMG-EL5W-DOBXTD	L.E.D.	65	5000	1	104W	6728	0-10V DRIVER	1	-
N	GROUND	8" ROUND, 42" TALL BOLLARD WITH EXTRUDED ALUMINUM SHAFT AND DIE-CAST ALUMINUM REFLECTOR AND TOP CAP, 3000K, ASYMMETRIC DISTRIBUTION, TEXTURED DARK BRONZE FINISH.	LITHONIA	DSXB LED-12C-530-30K-ASY-MVOLT-DMG-DOBXTD	L.E.D.	-	3000	1	22W	985	0-10V DRIVER	1	-
P	WALL SURFACE	WET LOCATION THERMOPLASTIC EMERGENCY LIGHT WITH 2 HEADS, NICKEL-CADMIUM BATTERY AND SELF DIAGNOSTICS	LITHONIA	WLTU-LED	L.E.D.	-	-	2	1.9W	-	-	1	-
Q	RECESSED	WET LOCATION 6" OPEN REFLECTOR DOWNLIGHT WITH CLEAR, SEMI-SPECULAR DIFFUSER	GOTHAM	EVO-35/30-6AR-MSS-LWD-MVOLT-EZ10	L.E.D.	-	3500	1	36.6W	3077	0-10V DRIVER	1	-
EXIT	WALL SURFACE/ SUSPENDED	DIE-CAST ALUMINUM EXIT SIGN WITH MATTE BLACK HOUSING AND BRUSHED ALUMINUM STENCIL FACE WITH GREEN LETTERING, NICKEL-CADMIUM BATTERY BACKUP AND SELF DIAGNOSTICS	LITHONIA	LE-S-G-ELN-SD	L.E.D.	-	-	1	1.7W	-	0-10V DRIVER	1	-

NOTES: (APPLICABLE TO LUMINAIRE SCHEDULE ONLY)

- LAMP TYPES ARE INDICATED BY INDUSTRY GENERIC DESIGNATIONS; SEE SPECIFICATIONS FOR APPROVED MANUFACTURERS.
- CATALOG NUMBERS FOR LUMINAIRES INDICATE THE TYPE AND QUALITY OF THE LUMINAIRE TO BE PROVIDED BY THE CONTRACTOR AND ARE GENERAL IN NATURE. THE CATALOG NUMBERS ARE NOT INTENDED TO INDICATE AN ACTUAL ORDER MODEL NUMBER. IT IS THE CONTRACTOR'S RESPONSIBILITY TO PROVIDE LUMINAIRES WITH THE TYPE OF LAMP, BALLAST, LENS OR DIFFUSER, AND CONSTRUCTION FEATURES AS INDICATED IN THE SPECIFICATIONS.
- WHERE A LUMINAIRE IS NOTED AS "NO EQUAL," SUBSTITUTIONS WILL NOT BE ACCEPTED. EQUIVALENT LUMINAIRES WILL BE ACCEPTED PROVIDED THEY ARE PROVEN TO BE EQUAL TO, OR BETTER THAN, THE SPECIFIED LUMINAIRE IN ALL RESPECTS. THIS SHALL INCLUDE, BUT NOT BE LIMITED TO, CONSTRUCTION FEATURES, APPEARANCE, AND PERFORMANCE. SUBMIT THE FOLLOWING FOR EACH PROPOSED SUBSTITUTION:
 - SAMPLE OF PROPOSED EQUIVALENT LUMINAIRE FOR TABLE-TOP EVALUATION. SAMPLE SHALL BE AN EXACT MATCH TO THE PROPOSED SUBSTITUTION INCLUDING ALL FEATURES, FINISHES, LAMPING, OPTIONS, ACCESSORIES, MOUNTING BRACKETS, ETC. SAMPLE SHALL INCLUDE 120V CORD AND NEMA 5-20P PLUG FOR OPERATIONAL TEST DURING TABLE-TOP EVALUATION.
 - POINT-BY-POINT LIGHT LEVEL CALCULATIONS IN 3-DIMENSIONAL LIGHTING CALCULATION SOFTWARE TO ILLUSTRATE GUARANTEED ILLUMINATION LEVELS. EACH SPACE AFFECTED BY A SUBSTITUTION SHALL BE MODELED AND CALCULATED USING INDUSTRY STANDARD VALUES FOR REFLECTANCES, LIGHT LOSS FACTOR, ETC. ENGINEER WILL COMPARE TO BASIS OF DESIGN LUMINAIRE AND ENGINEER'S CALCULATIONS TO APPROVE OR REJECT SUBSTITUTE LUMINAIRE. PROVIDE IES FILE TO ENGINEER FOR PROPOSED SUBSTITUTE ALONG WITH CALCULATION RESULTS.
 - POINT-BY-POINT COMPARATIVE DATA IN SIDE-BY-SIDE FORMAT COMPARING FEATURES OF SUBSTITUTE LUMINAIRE TO BASIS-OF-DESIGN LUMINAIRE.
 - ALL REQUIREMENTS OF DIVISION 1 SECTION "SUBSTITUTION PROCEDURES."
- COORDINATE CONTROL COMPATIBILITY BETWEEN BALLAST/DRIVER TYPES FOR ALL DIMMED LUMINAIRES WITH MANUFACTURER AND MODEL OF DIMMING CONTROL DEVICES.
- PROVIDE EXIT SIGNS WITH SINGLE FACE OR DOUBLE FACE AND WITH OR WITHOUT CHEVRONS AS INDICATED ON THE DRAWINGS. PROVIDE RED OR GREEN LETTERING AS REQUIRED BY AHJ.
- ALL MOUNTING HEIGHTS SHALL BE AS INDICATED ON THE DRAWINGS OR AS DIRECTED BY THE ARCHITECT OR ENGINEER. MOUNTING HEIGHTS OF WALL MOUNTED LUMINAIRES SHALL BE MEASURED FROM THE FINISHED FLOOR TO THE CENTERLINE OF THE LUMINAIRE. MOUNTING HEIGHTS OF CEILING SUSPENDED LUMINAIRES SHALL BE MEASURED FROM THE FINISHED FLOOR TO THE BOTTOM OF THE LUMINAIRE.
- IN WAREHOUSE, MOUNT FIXTURE 25' AFF. ABOVE AND BELOW PLATFORM, MOUNT FIXTURES 12' AFF.


LCP2 SCHEDULE ①										LOCATION: RM M2X -- ELECTRICAL MEZZANINE	
REMOTE INPUT PANEL FOR SWITCHED LOADS										BASIS OF DESIGN: LEVITON GREENMAX REMOTE M1X SURFACE MOUNTED PANEL WITH KNOCKOUTS, NEMA 1 ENCLOSURE, WITH DIGITAL TIME CLOCK	
RELAY NO.	RELAY TYPE	PANELBOARD CKT	VOLTAGE	LUMINAIRE TYPE	LOCATION	CONTROL CHANNEL	CONTROL TYPE	LOCATION OF MANUAL CONTROL	NOTES		
1	SINGLE POLE, N.C.	3(HL1A)	277V	B, B1	RM 100 -- CORRIDOR, RM 50 -- VESTIBULE	1	OCCUPANCY SENSOR, TIME CLOCK, SWITCH	ENTRANCE DOOR 50.1	-		
2	SINGLE POLE, DIMMING	3(HL1A)	277V	F, F1, G	RM 51 -- WAREHOUSE LOBBY, RM 53 -- WAREHOUSE OFFICE	2	OCCUPANCY SENSOR, DIMMER SWITCH	DOORS 51, 53.1, 53.2	-		
3	SINGLE POLE, N.C.	3(HL1A)	277V	D	RM 30 -- LOADING DOCK	3	OCCUPANCY SENSOR, SWITCH	DOOR 30F	-		
4	SINGLE POLE, N.C.	3(HL1A)	277V	K	STAIR 31	4	OCCUPANCY SENSOR	-	-		
5	SINGLE POLE, N.C.	3(HL1A)	277V	D	RM 34 -- DOCK TREATMENT	5	OCCUPANCY SENSOR, SWITCH	DOOR 34.2	-		
6	SINGLE POLE, N.C.	5(HL1A)	277V	D	RM 36A -- RECEIVING DOCK (DIRTY)	6	OCCUPANCY SENSOR, SWITCH	DOOR 36A.1	-		
7	SINGLE POLE, N.C.	5(HL1A)	277V	D	RM 36B -- RECEIVING DOCK (CLEAN)	7	OCCUPANCY SENSOR, SWITCH	DOOR 36B.3	-		
8	SINGLE POLE, N.C.	5(HL1A)	277V	K	STAIR 37, STAIR 38	4	OCCUPANCY SENSOR	-	-		
9	SINGLE POLE, DIMMING	5(HL1A)	277V	F, F1	RM 153 -- HIGH DENSITY STORAGE, RM 156 -- WORK AREA	8	OCCUPANCY SENSOR, DIMMER SWITCH	ENTRANCE TO RM 153 AND 156	-		

SPECIAL NOTES: (APPLY TO THIS DRAWING ONLY)

- TIMECLOCK CONTROL SHALL BE THE PRIORITY CONTROL. IF THE OUTDOOR LIGHT LEVEL DROPS BELOW AN ACCEPTABLE LEVEL, THE PHOTOSENSOR SHALL TURN THE LIGHTS "ON" EARLIER THEN SCHEDULED IN THE AFTERNOON/EVENING. IF THE LIGHT LEVEL IS NOT ADEQUATE IN THE MORNING WHEN THE LIGHTS ARE SCHEDULED TO TURN "OFF", THE PHOTOSENSOR SHALL CONTROL THE LIGHTS TO REMAIN "ON" UNTIL THE LIGHT LEVEL IS ADEQUATE.

Revisions:	Date
SCHEMATIC DESIGN (30%) SUBMISSION	03/25/15
DESIGN DEVELOPMENT (60%) SUBMISSION	09/11/15
CONSTRUCTION DOCUMENTS (90% SUBMISSION)	11/23/15
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ELECTRICAL SCHEDULES	
Approved: Associate Director for Operations	
Approved: Director, Medical Center	

PROJECT TITLE				Date
WAREHOUSE RENOVATION & EXPANSION				03/17/16
Scale				VA Project Number
NONE				512-530
Building Number				Drawing Number
360				E700
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JFR				
Drawn				
MLS				
Location				
PERRY POINT, MD				

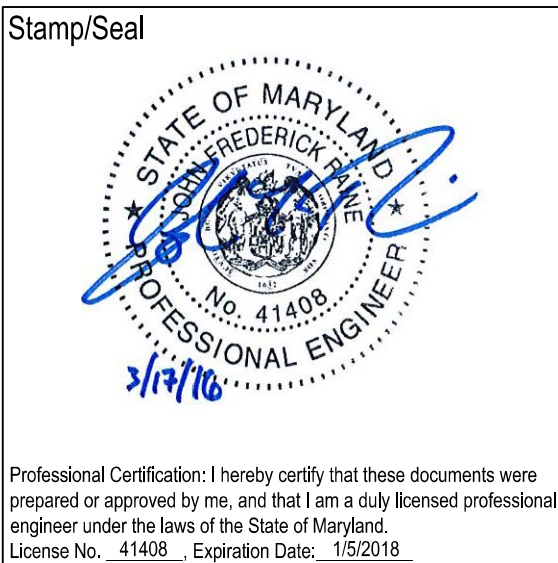DISCONNECT SWITCH SCHEDULE	
DESIGNATION	AMPS
DS-AH6	30
DS-P-HHW	30

NOTES: (APPLICABLE TO DISCONNECT SWITCH SCHEDULE ONLY)

- ELECTRICAL CONTRACTOR SHALL PROVIDE FUSE AND COORDINATE EXACT EQUIPMENT FUSE SIZE DURING CONSTRUCTION WITH MOTOR OR EQUIPMENT NAMEPLATE DATA.
- ALL DISCONNECTS SHALL BE HEAVY DUTY TYPE WITH GROUND LUG AND CLASS RK FUSE REJECTION KIT.
- DISCONNECT TO BE INTERLOCKED WITH VSD-6 SO THAT VSD-6 MAY NOT BE STARTED WHILE DS-AH6 IS OPEN. PROVIDE SIGN ON DS-AH6 STATING "MOTOR CONTROLLED BY VSD-6 IN MECH ROOM M3X".



MANUAL TRANSFER SWITCH SCHEDULE													
DESIGNATION	AMPACITY	PHASE	WIRES	SWITCHED POLES	LOAD SHED	BYPASS ISOLATION	PRIORITY	TRANSITION	VOLTAGE	MOUNTING	MINIMUM AIC RATING	REMARKS	
MTS-1	2000A	3	4	3	NO	NO	N/A	OPEN	480V	FLOOR	50KAIC	-	

DRY-TYPE TRANSFORMER SCHEDULE													
TRANSFORMER DESIGNATION	SIZE (KVA)	RATING	PRIMARY VOLTAGE	PRIMARY CIRCUIT			PRIMARY CB		SECONDARY VOLTAGE	SECONDARY CIRCUIT			NOTES
T1	225	-	480V-3PH	NUMBER	SIZE (PHAS, GW)	CONDUIT	POLE	TRIP AMPS	12+3GW	NUMBER	SIZE (PHAS, GW)	CONDUIT	FLOOR MOUNTED
				3+GW	500KCML+3#3	3-1/2"	3	350A	208Y/120V-3PH	12+3GW	300KCML+3#2/0	(3) 3"	

MECHANICAL EQUIPMENT ELECTRICAL CONNECTION SCHEDULE									
EQUIPMENT DESIGNATION	KW	HP	MCA	FLA	VOLTAGE-PHASE	LOAD (KVA)	WIRING	DISCONNECTING MEANS	NOTES
360-AH1	-	7.5	14.88	11.9	480V-3PH	9.89	3#10+1#10GW IN 3/4"C	EXISTING VSD-1	-
360-AH2	-	15	28.75	23.0	480V-3PH	19.11	3#4+1#10GW IN 1-1/4"C	EXISTING VSD-2	-
360-AH3	-	1.5	4.12	3.3	480V-3PH	2.74	3#12+1#12GW IN 3/4"C	EXISTING VSD-3	-
360-AH4 (SF4)	-	15	-	21.0	480V-3PH	17.5	3#10+1#10GW IN 3/4"C	FACTORY INSTALLED VSD-4	-
360-AH5 (SF5)	-	10	-	14.0	480V-3PH	11.7	3#12+1#12GW IN 3/4"C	FACTORY INSTALLED VSD-5	-
360-AH6 (SF6)	-	7.5	-	11.0	480V-3PH	9.15	3#12+1#12GW IN 3/4"C	VSD-6/DS-AH6	-
360-AH7 (SF7)	-	2	-	3.4	480V-3PH	2.83	3#12+1#12GW IN 3/4"C	FACTORY INSTALLED VSD-7	-
UH-1	-	-	-	-	120V-1PH	0.60	2#12+1#12GW IN 3/4"C	FACTORY INSTALLED DISCONNECT	-
360-EF6	-	1/4	-	5.8	120V-1PH	0.70	2#12+1#12GW IN 3/4"C	MANUAL MOTOR STARTER SWITCH	-
360-RF4	-	5	-	7.6	480V-3PH	6.32	3#12+1#12GW IN 3/4"C	VSD-RF4	-
360-RF5	-	3	-	4.8	480V-3PH	4	3#12+1#12GW IN 3/4"C	VSD-RF-5	-
360-RF7	-	0.75	-	1.6	480V-3PH	1.2	3#12+1#12GW IN 3/4"C	VSD-RF-6	-
360-P-HHW	-	(2) 3	-	4.8	480V-3PH	4.00	3#12+1#12GW IN 3/4"C	DS-P-HHW/INT. CONTROL PANEL	-
360-P-HWR	-	1/4	-	5.8	120V-1PH	0.70	2#12+1#12GW IN 3/4"C	HOA MAN. MOTOR STARTER SW.	-
360-PHP-4	0.218	-	-	5.0	120V-1PH	0.218	2#12+1#12GW IN 3/4"C	HOA MAN. MOTOR STARTER SW.	-
360-PHP-5	0.218	-	-	5.0	120V-1PH	0.218	2#12+1#12GW IN 3/4"C	HOA MAN. MOTOR STARTER SW.	-
360-PHP-6	0.117	-	-	5.0	120V-1PH	0.117	2#12+1#12GW IN 3/4"C	HOA MAN. MOTOR STARTER SW.	-
360-PHP-7	0.117	-	-	5.0	120V-1PH	0.117	2#12+1#12GW IN 3/4"C	HOA MAN. MOTOR STARTER SW.	-
DOCK LIFT	-	5	-	15.2	208V-3PH	5.5	3#12+1#12GW IN 3/4"C	CMS-DOCK LIFT	-
EXISTING HEAT PUMP 13	-	-	34.00	-	208V-1PH	7.07	2#4+1#10GW IN 1"C	EXISTING DISCONNECT	-
FAN CF-6	-	0.375	-	3.6	120V-1PH	0.43	2#12+1#12GW IN 3/4"C.	MANUAL MOTOR STARTER SWITCH	-
360-P-CHW	-	(2) 5	-	7.6	480V-3PH	6.32	3#12+1#12GW IN 3/4"C	VSD-P-CHW	-
FIRE PUMP	-	75	-	96	480V-3PH	79.9	REFER TO RISER	FIRE PUMP CONTROLLER	-
JOCKEY PUMP	-	1.5	-	3.0	480V-3PH	2.2	3#12+1#12GW IN 3/4"C	JOCKEY PUMP CONTROLLER	-

FEEDER SCHEDULE							
FEEDER TAG DESIGNATION	NOMINAL AMPERE RATING	NUMBER OF SETS	PHASE (A-B-C) CONDUCTOR	NEUTRAL CONDUCTOR	GROUND CONDUCTOR	CONDUIT SIZE	
			COPPER SIZE AWG/KCML	COPPER SIZE AWG/KCML	QUANTITY OF CONDUCTORS	COPPER SIZE AWG/KCML	(3P+G) (3P+H+G) (3P+2H+G) OR (3P+H+2G)
100.X	100	1	1	1	1	8	1-1/2" 2" 2"
150.X	150	1	1/0	1/0	1	6	2" 2" 2"
200.X	200	1	3/0	3/0	1	6	2" 2-1/2" 2-1/2"
225.X	225	1	4/0	4/0	1	4	2-1/2" 2-1/2" 3"
350.X	350	1	500	500	1	3	3-1/2" 3-1/2" 3-1/2"
800.X	800	3	300	300	1	1/0	3" 3" 3-1/2"
2000.X	2000	6	400	400	1	250	3" 3-1/2" 3-

BUS AMPACITY: 225A MAIN TYPE: 225A MCB SERVICE: 3 PHASE, 4 WIRE, 480Y/277 VOLTS MIN. RATING: 35K AIC RMS SYMMETRICAL AMPS										MOUNTING: SURFACE SECTION: 1 OF 1 ENCLOSURE: NEMA 1 LOCATION: MECHANICAL ROOM M4X									
PANELBOARD HM2B																			
Ckt	POLE	LOAD DESCRIPTION	NOTE	CKT BREAKER			KVA PER PHASE						CKT BREAKER			NOTE	LOAD DESCRIPTION	Ckt	POLE
				P	TA	AUX	PHASE A		PHASE B		PHASE C		P	TA	AUX				
1	1	360-AH3	-	3	15	-	0.92	0.64					1	20	-	LIGHTING - ROOM M3X	2	2	
3	3	{ }	-	-	-	-			0.92	-			1	20	-	SPARE	4	4	
5	5	{ }	-	-	-	-					0.92	-	1	20	-	SPARE	6	6	
7	7	360-AH4	-	3	40	-	5.83	1.33					3	15	-	360-RF5	8	8	
9	9	{ }	-	-	-	-			5.83	1.33			-	-	-	{ }	10	10	
11	11	{ }	-	-	-	-					5.83	1.33	-	-	-	{ }	12	12	
13	13	360-AH5	-	3	25	-	3.90	1.60					3	15	-	360-P-HHW	14	14	
15	15	{ }	-	-	-	-			3.90	1.60			-	-	-	{ }	16	16	
17	17	{ }	-	-	-	-					3.90	1.60	-	-	-	{ }	18	18	
19	19	360-P-CHW	-	3	15	-	2.10	0.40					3	15	-	360-RF-7	20	20	
21	21	{ }	-	-	-	-			2.10	0.40			-	-	-	{ }	22	22	
23	23	{ }	-	-	-	-					2.10	0.40	-	-	-	{ }	24	24	
25	25	JOCKEY PUMP	-	3	15	-	0.70	0.96					3	15	-	360-AH7	26	26	
27	27	{ }	-	-	-	-			0.70	0.96			-	-	-	{ }	28	28	
29	29	{ }	-	-	-	-					0.70	0.96	-	-	-	{ }	30	30	
31	31	SPARE	-	1	20	-	-	-	-	-	-	-	1	20	-	SPARE	32	32	
33	33	SPARE	-	1	20	-	-	-	-	-	-	-	1	20	-	SPARE	34	34	
35	35	SPARE	-	1	20	-	-	-	-	-	-	-	1	20	-	SPARE	36	36	
37	37	SPACE WITH PROVISIONS	-	1	-	-	-	-	-	-	-	-	1	-	-	SPACE WITH PROVISIONS	38	38	
39	39	SPACE WITH PROVISIONS	-	1	-	-	-	-	-	-	-	-	1	-	-	SPACE WITH PROVISIONS	40	40	
41	41	SPACE WITH PROVISIONS	-	1	-	-	-	-	-	-	-	-	1	-	-	SPACE WITH PROVISIONS	42	42	
AUXILIARIES:							13.45	4.93	13.45	4.29	13.45	4.29	CONNECTED LOAD: 53.86KVA DEMAND LOAD: 53.86KVA DEMAND AMPS: 64.81A						
a AFCI BREAKER							18.38		17.74		17.74		<input checked="" type="checkbox"/> GROUND BUS <input type="checkbox"/> SPLIT BUS <input type="checkbox"/> FEED THRU LUGS <input type="checkbox"/> SUB FEED LUGS <input type="checkbox"/> ISOLATED GROUND BUS <input type="checkbox"/> INTEGRAL SPD/TVSS						
e HANDLE PADLOCK							PHASE A: 66.35A PHASE B: 64.04A PHASE C: 64.04A												
b GFCI BREAKER (5mA)																			
c GFEP BREAKER (30mA)																			
d SHUNT TRIP BREAKER																			
f HANDLE CLAMP																			
g RED CB HANDLE																			

NOTES: (APPLICABLE TO PANELBOARD HM2B ONLY)

1. -

BUS AMPACITY: 225A MAIN TYPE: 150A MCB SERVICE: 3 PHASE, 4 WIRE, 480Y/277 VOLTS MIN. RATING: 35K AIC RMS SYMMETRICAL AMPS										MOUNTING: SURFACE SECTION: 1 OF 1 ENCLOSURE: NEMA 1 LOCATION: ELECTRICAL ROOM M2X									
Ckt	POLE	LOAD DESCRIPTION	NOTE	CKT BREAKER			KVA PER PHASE						CKT BREAKER			NOTE	LOAD DESCRIPTION	Ckt	POLE
				P	TA	AUX	PHASE A		PHASE B		PHASE C		P	TA	AUX				
1	1	360-AH-1	-	3	25	-	3.29	1.73					1	20	-	-	LIGHTING - MEZZANINE	2	2
3	3	{ }	-	-	-	-			3.29	3.69			1	20	-	-	LIGHTING - SOUTH WAREHOUSE	4	4
5	5	{ }	-	-	-	-					3.29	2.96	1	20	-	-	LIGHTING - SOUTH WAREHOUSE	6	6
7	7	360-AH-2	-	3	60	-	6.37	2.86					1	20	-	-	LIGHTING - SOUTH WAREHOUSE	8	8
9	9	{ }	-	-	-	-			6.37	0.51			1	20	-	-	LIGHTING - ROOMS M2X, M3X	10	10
11	11	{ }	-	-	-	-					6.37	1.28	1	20	-	-	LIGHTING - NORTH WAREHOUSE	12	12
13	13	360-AH-6	-	3	20	-	3.10	0.88					1	20	-	-	LIGHTING - NORTH WAREHOUSE	14	14
15	15	{ }	-	-	-	-			3.10	2.63			1	20	-	-	LIGHTING - NORTH WAREHOUSE	16	16
17	17	{ }	-	-	-	-					3.10	2.63	1	20	-	-	LIGHTING - NORTH WAREHOUSE	18	18
19	19	360-RF4	-	3	15	-	2.10	1.28					1	20	-	-	LIGHTING - NORTH WAREHOUSE	20	20
21	21	{ }	-	-	-	-			2.10	2.83			1	20	-	-	LIGHTING - NORTHEAST ROOMS	22	22
23	23	{ }	-	-	-	-					2.10	0.42	1	20	-	-	EXTERIOR LIGHTING	24	24
25	25	SPARE	-	1	20	-	-	-					1	20	-	-	SPARE	26	26
27	27	SPARE	-	1	20	-	-	-					1	20	-	-	SPARE	28	28
29	29	SPARE	-	1	20	-	-	-					1	20	-	-	SPARE	30	30
31	31	SPARE	-	1	20	-	-	-					1	20	-	-	SPARE	32	32
33	33	SPARE	-	1	20	-	-	-					1	20	-	-	SPARE	34	34
35	35	SPARE	-	1	20	-	-	-					1	20	-	-	SPARE	36	36
37	37	SPACE WITH PROVISIONS	-	1	-	-	-	-					1	-	-	-	SPACE WITH PROVISIONS	38	38
39	39	SPACE WITH PROVISIONS	-	1	-	-	-	-					1	-	-	-	SPACE WITH PROVISIONS	40	40
41	41	SPACE WITH PROVISIONS	-	1	-	-	-	-					1	-	-	-	SPACE WITH PROVISIONS	42	42
AUXILIARIES:							14.86	6.75	14.86	9.66	14.86	7.29	CONNECTED LOAD: 68.28KVA <input checked="" type="checkbox"/> GROUND BUS						
a AFCI BREAKER							21.61		24.52		22.15	DEMAND LOAD: 68.28KVA <input type="checkbox"/> SPLIT BUS							
b GFCI BREAKER (5mA)							DEMAND AMPS: 82.17A										<input type="checkbox"/> FEED THRU LUGS		
c GFEP BREAKER (30mA)							PHASE A: 78.01A PHASE B: 88.52A PHASE C: 79.96A										<input type="checkbox"/> 200% NEUTRAL BUS & LUGS <input type="checkbox"/> SUB FEED LUGS		
d SHUNT TRIP BREAKER																	<input type="checkbox"/> ISOLATED GROUND BUS <input type="checkbox"/> INTEGRAL SPD/TVSS		
e HANDLE PADLOCK																			
f HANDLE CLAMP																			
g RED CB HANDLE																			

NOTES: (APPLICABLE TO PANELBOARD HL2A ONLY)

1. -

BUS AMPACITY: 100A MAIN TYPE: 100A MCB SERVICE: 3 PHASE, 4 WIRE, 480Y/277 VOLTS MIN. RATING: 35K AIC RMS SYMMETRICAL AMPS										MOUNTING: SURFACE SECTION: 1 OF 1 ENCLOSURE: NEMA 1 LOCATION: ELECTRICAL ROOM 29									
PANELBOARD HL1C																			
Ckt	POLE	LOAD DESCRIPTION	NOTE	CKT BREAKER			KVA PER PHASE						CKT BREAKER			NOTE	LOAD DESCRIPTION	Ckt	POLE
				P	TA	AUX	PHASE A		PHASE B		PHASE C		P	TA	AUX				
1	1	LIGHTING -- WEST	-	1	20	-	1.63	-					1	20	-	-	SPARE	2	2
3	3	LIGHTING -- SOUTHWEST	-	1	20	-			2.26	-			1	20	-	-	SPARE	4	4
5	5	LIGHTING -- SOUTHEAST	-	1	20	-					1.75	-	1	20	-	-	SPARE	6	6
7	7	EXTERIOR LIGHTING	-	1	20	-	0.83	-					1	20	-	-	SPARE	8	8
9	9	SPARE	-	1	20	-			-	-			1	20	-	-	SPARE	10	10
11	11	SPARE	-	1	20	-					-	-	1	20	-	-	SPARE	12	12
13	13	SPARE	-	1	20	-							1	20	-	-	SPARE	14	14
15	15	SPARE	-	1	20	-							1	20	-	-	SPARE	16	16
17	17	SPARE	-	1	20	-							1	20	-	-	SPARE	18	18
19	19	SPARE	-	1	20	-							1	20	-	-	SPARE	20	20
21	21	SPARE	-	1	20	-							1	20	-	-	SPARE	22	22
23	23	SPARE	-	1	20	-							1	20	-	-	SPARE	24	24
25	25	SPARE	-	1	20	-							1	20	-	-	SPARE	26	26
27	27	SPARE	-	1	20	-							1	20	-	-	SPARE	28	28
29	29	SPARE	-	1	20	-							1	20	-	-	SPARE	30	30
31	31	SPARE	-	1	20	-							1	20	-	-	SPARE	32	32
33	33	SPARE	-	1	20	-							1	20	-	-	SPARE	34	34
35	35	SPARE	-	1	20	-							1	20	-	-	SPARE	36	36
37	37	SPACE WITH PROVISIONS	-	1	-	-							1	-	-	-	SPACE WITH PROVISIONS	38	38
39	39	SPACE WITH PROVISIONS	-	1	-	-							1	-	-	-	SPACE WITH PROVISIONS	40	40
41	41	SPACE WITH PROVISIONS	-	1	-	-							1	-	-	-	SPACE WITH PROVISIONS	42	42
AUXILIARIES:							2.46	-	2.26	-	1.75	-	CONNECTED LOAD: 6.47KVA DEMAND LOAD: 6.47KVA DEMAND AMPS: 7.78A						
a AFCI BREAKER							2.46		2.26		1.75		<input checked="" type="checkbox"/> GROUND BUS <input type="checkbox"/> SPLIT BUS						
b GFCI BREAKER (5mA)							PHASE A: 8.88A PHASE B: 8.16A PHASE C: 6.32A							<input type="checkbox"/> FEED THRU LUGS					
c GFEP BREAKER (30mA)														<input type="checkbox"/> 200% NEUTRAL BUS & LUGS					
d SHUNT TRIP BREAKER														<input type="checkbox"/> ISOLATED GROUND BUS					
e HANDLE PADLOCK														<input type="checkbox"/> SUB FEED LUGS					
f HANDLE CLAMP														<input type="checkbox"/> INTEGRAL SPD/TVSS					
g RED CB HANDLE																			

NOTES: (APPLICABLE TO PANELBOARD HL1C ONLY)

1. -

LCP1 SCHEDULE ①						LOCATION: RM M2X – ELECTRICAL MEZZANINE BASIS OF DESIGN: LEVITON GREENMAX 48 M2X SURFACE MOUNTED PANEL WITH KNOCKOUTS, NEMA 1 ENCLOSURE, WITH DIGITAL TIME CLOCK				
LIGHTING CONTROL SYSTEM RELAY PANEL FOR SWITCHED LOADS										
RELAY NO.	RELAY TYPE	PANELBOARD CKT	VOLTAGE	LUMINAIRE TYPE	LOCATION	CONTROL CHANNEL	CONTROL TYPE	LOCATION OF MANUAL CONTROL	NOTES	
1	SINGLE POLE, N.C.	12(HL2A)	277V	C, C1	RM 26 – NORTH WAREHOUSE – ZONE 1	1	OCCUPANCY SENSOR, TIME CLOCK, SWITCH	DOORS 26.3, 26.2, 26.7, 26.9	–	
2	SINGLE POLE, N.C.	14(HL2A)	277V	C, C1	RM 26 – NORTH WAREHOUSE – ZONE 2	2	OCCUPANCY SENSOR, TIME CLOCK, SWITCH	DOORS 26.3, 26.2, 26.7, 26.9	–	
3	SINGLE POLE, N.C.	16(HL2A)	277V	C, C1	RM 26 – NORTH WAREHOUSE – ZONE 3	3	OCCUPANCY SENSOR, TIME CLOCK, SWITCH	DOORS 26.3, 26.2, 26.7, 26.9	–	
4	SINGLE POLE, N.C.	16(HL2A)	277V	C, C1	RM 26 – NORTH WAREHOUSE – ZONE 4	4	OCCUPANCY SENSOR, TIME CLOCK, SWITCH	DOORS 26.3, 26.2, 26.7, 26.9	–	
5	SINGLE POLE, N.C.	16(HL2A)	277V	C, C1	RM 26 – NORTH WAREHOUSE – ZONE 5	5	OCCUPANCY SENSOR, TIME CLOCK, SWITCH	DOORS 26.3, 26.2, 26.7, 26.9	–	
6	SINGLE POLE, N.C.	18(HL2A)	277V	C, C1	RM 26 – NORTH WAREHOUSE – ZONE 6	6	OCCUPANCY SENSOR, TIME CLOCK, SWITCH	DOORS 26.3, 26.2, 26.7, 26.9	–	
7	SINGLE POLE, N.C.	18(HL2A)	277V	C, C1	RM 26 – NORTH WAREHOUSE – ZONE 7	7	OCCUPANCY SENSOR, TIME CLOCK, SWITCH	DOORS 26.3, 26.2, 26.7, 26.9	–	
8	SINGLE POLE, N.C.	18(HL2A)	277V	C, C1	RM 26 – NORTH WAREHOUSE – ZONE 8	8	OCCUPANCY SENSOR, TIME CLOCK, SWITCH	DOORS 26.3, 26.2, 26.7, 26.9	–	
9	SINGLE POLE, N.C.	20(HL2A)	277V	C, C1	RM 26 – NORTH WAREHOUSE – ZONE 9	9	OCCUPANCY SENSOR, TIME CLOCK, SWITCH	DOORS 26.3, 26.2, 26.7, 26.9	–	
10	SINGLE POLE, DIMMING	22(HL2A)	277V	A, A1	RM 5 – COPY/PRINT	10	OCCUPANCY SENSOR, DIMMER SWITCH	DOORS 5.1, 5.2	–	
11	SINGLE POLE, DIMMING	22(HL2A)	277V	F, F1	RM 6 – TRAINING – DAYLIGHT ZONE	11	PHOTOCELL, OCCUPANCY SENSOR, DIMMER SWITCH	DOOR 6	–	
12	SINGLE POLE, DIMMING	22(HL2A)	277V	F, F1	RM 6 – TRAINING	12	OCCUPANCY SENSOR, DIMMER SWITCH	DOOR 6	–	
13	SINGLE POLE, DIMMING	22(HL2A)	277V	A	RM 4 – BREAK ROOM	13	OCCUPANCY SENSOR, DIMMER SWITCH	DOOR 4.1	–	
14	SINGLE POLE, N.C.	22(HL2A)	277V	A, A1, B, B1	RM 1 – VESTIBULE, RM 2 – LOBBY, RMS 11, 12 – CORRIDOR	14	OCCUPANCY SENSOR, TIME CLOCK, SWITCH	DOORS 1, 11	–	
15	SINGLE POLE, N.C.	22(HL2A)	277V	B, B1	RM 7 – WOMEN’S ROOM	15	OCCUPANCY SENSOR, SWITCH	DOOR 7	–	
16	SINGLE POLE, N.C.	22(HL2A)	277V	B, B1	RM 8 – MEN’S ROOM	16	OCCUPANCY SENSOR, SWITCH	DOOR 8	–	
17	SINGLE POLE, N.C.	22(HL2A)	277V	K	STAIR 9	17	OCCUPANCY SENSOR	–	–	
18	SINGLE POLE, N.C.	22(HL2A)	277V	M	EXTERIOR LIGHTS – NORTH WAREHOUSE BUILDING	18	PHOTOCELL, TIME CLOCK	–	–	
19	SINGLE POLE, N.C.	7(HL1C)	277V	M, N	EXTERIOR LIGHTS – SOUTH WAREHOUSE BUILDING	19	PHOTOCELL, TIME CLOCK	–	–	
20	SINGLE POLE, N.C.	2(HL2A)	277V	C, C1	RM 21 – SOUTH WAREHOUSE – ZONE 1	20	OCCUPANCY SENSOR, TIME CLOCK, SWITCH	STAIR EXIT	–	
21	SINGLE POLE, N.C.	4(HL2A)	277V	C, C1	RM 21 – SOUTH WAREHOUSE – ZONE 2	21	OCCUPANCY SENSOR, TIME CLOCK, SWITCH	DOORS 11, 26.7, 26.9, 30F, 53.2	–	
22	SINGLE POLE, N.C.	4(HL2A)	277V	C, C1	RM 21 – SOUTH WAREHOUSE – ZONE 3	21	OCCUPANCY SENSOR, TIME CLOCK, SWITCH	DOORS 11, 26.7, 26.9, 30F, 53.2	–	
23	SINGLE POLE, N.C.	4(HL2A)	277V	C, C1	RM 21 – SOUTH WAREHOUSE – ZONE 4	22	OCCUPANCY SENSOR, TIME CLOCK, SWITCH	DOORS 11, 26.7, 26.9, 30F, 53.2	–	
24	SINGLE POLE, N.C.	6(HL2A)	277V	C, C1	RM 21 – SOUTH WAREHOUSE – ZONE 5	23	OCCUPANCY SENSOR, TIME CLOCK, SWITCH	DOORS 11, 26.7, 26.9, 30F, 53.2	–	
25	SINGLE POLE, N.C.	6(HL2A)	277V	C, C1	RM 21 – SOUTH WAREHOUSE – ZONE 6	24	OCCUPANCY SENSOR, TIME CLOCK, SWITCH	DOORS 11, 26.7, 26.9, 30F, 53.2	–	
26	SINGLE POLE, N.C.	4(HL2A)	277V	C, C1	RM 21 – SOUTH WAREHOUSE – ZONE 7	25	OCCUPANCY SENSOR, TIME CLOCK, SWITCH	DOORS 11, 26.7, 26.9, 30F, 53.2	–	
27	SINGLE POLE, N.C.	6(HL2A)	277V	C, C1	RM 21 – SOUTH WAREHOUSE – ZONE 8	26	OCCUPANCY SENSOR, TIME CLOCK, SWITCH	DOORS 11, 26.7, 26.9, 30F, 53.2	–	
28	SINGLE POLE, N.C.	1(HL1C)	277V	C, C1	RM 21 – SOUTH WAREHOUSE – ZONE 9	27	OCCUPANCY SENSOR, TIME CLOCK, SWITCH	DOORS 11, 26.7, 26.9, 30F, 53.2	–	
29	SINGLE POLE, N.C.	8(HL2A)	277V	C, C1	RM 20 – WAREHOUSE EQUIPMENT	28	OCCUPANCY SENSOR, SWITCH	DOORS 20.1, 20.3	–	
30	SINGLE POLE, N.C.	8(HL2A)	277V	C, C1	RM 151 – LAUNDRY AREA, RM 159 – LAUNDRY STORAGE	29	OCCUPANCY SENSOR, SWITCH	DOOR 36A.1	–	
31	SINGLE POLE, N.C.	8(HL2A)	277V	C, C1	RM 24 – WAREHOUSE HIGH DENSITY STORAGE	30	OCCUPANCY SENSOR, SWITCH	DOOR 24.1	–	
32	SINGLE POLE, N.C.	8(HL2A)	277V	C, C1	RM 25 – WAREHOUSE HIGH DENSITY STORAGE	31	OCCUPANCY SENSOR, SWITCH	DOOR 25.1	–	
33	SINGLE POLE, N.C.	1(HL1C)	277V	K	STAIRS	32	OCCUPANCY SENSOR	–	–	

BUS AMPACITY: 225A MAIN TYPE: 200A MCB SERVICE: 3 PHASE, 4 WIRE, 208Y/120 VOLTS MIN. RATING: 10K AIC RMS SYMMETRICAL AMPS										MOUNTING: SURFACE SECTION: 1 OF 1 ENCLOSURE: NEMA 1 LOCATION: ELECTRICAL ROOM 33									
PANELBOARD LR1D																			
OCT	POLE	LOAD DESCRIPTION	NOTE	OCT BREAKER			KVA PER PHASE						OCT BREAKER			NOTE	LOAD DESCRIPTION	OCT	POLE
				P	TA	AUX	PHASE A		PHASE B		PHASE C	P	TA	AUX					
1	1	RECEPTACLES - RMS 50,52,100	-	1	20	-	1.20	1.20					1	20	-	-	RECEPTACLES - RM 53	2	2
3	3	RECEPTACLES - RM 51	-	1	20	-			0.80	0.80			1	20	-	-	RECEPTACLES - RM 54	4	4
5	5	RECEPTACLES - RM 53	-	1	20	-					0.80	0.80	1	20	-	-	RECEPTACLES - RM 55	6	6
7	7	RECEPTACLES - RM 30	-	1	20	-	1.00	1.00					1	20	-	-	RECEPTACLES - RM 34	8	8
9	9	RECEPTACLES - RMS 25,26	-	1	20	-			1.20	0.80			1	20	-	-	RECEPTACLES - RM 35	10	10
11	11	RECEPTACLES - RM 25	-	1	20	-					0.80	1.20	1	20	-	-	OVERHEAD COIL DOOR, ROOM 30	12	12
13	13	360-P-HWR - RM 35	-	1	20	-	0.70	1.20					1	20	-	-	OVERHEAD COIL DOOR, ROOM 30	14	14
15	15	HEAT PUMP 13	-	2	60	-			3.54	1.20			1	20	-	-	OVERHEAD COIL DOOR, ROOM 30	16	16
17	17	{ }	-								3.54	1.20	1	20	-	-	OVERHEAD COIL DOOR, ROOM 34	18	18
19	19	DOCK LIFT	-	3	30	-	1.80	1.90					3	30	-	-	DOCK LIFT	20	20
21	21	{ }	-	-	-	-			1.90	1.80			-	-	-	{ }	22	22	
23	23	{ }	-	-	-	-					1.80	1.80	-	-	-	{ }	24	24	
25	25	FLOOR SCALE	-	1	20	-	1.00	1.20					1	20	-	-	UH-1	26	26
27	27	SUMP PUMP	-	1	20	-			0.20	-			1	20	-	-	SPARE	28	28
29	29	SPARE	-	1	20	-					-	-	1	20	-	-	SPARE	30	30
31	31	SPARE	-	1	20	-			-	-			1	20	-	-	SPARE	32	32
33	33	SPARE	-	1	20	-			-	-			1	20	-	-	SPARE	34	34
35	35	SPARE	-	1	20	-			-	-			1	20	-	-	SPARE	36	36
37	37	SPACE WITH PROVISIONS	-	1	-	-			-	-			1	-	-	-	SPACE WITH PROVISIONS	38	38
39	39	SPACE WITH PROVISIONS	-	1	-	-			-	-			1	-	-	-	SPACE WITH PROVISIONS	40	40
41	41	SPACE WITH PROVISIONS	-	1	-	-			-	-			1	-	-	-	SPACE WITH PROVISIONS	42	42
AUXILIARIES:							5.70	6.50	7.64	4.60	6.94	5.00	CONNECTED LOAD: 36.38KVA DEMAND LOAD: 25.71KVA DEMAND AMPS: 71.41A <input type="checkbox"/> 200% NEUTRAL BUS & LUGS <input type="checkbox"/> ISOLATED GROUND BUS						
a AFCI BREAKER b GFCI BREAKER (5mA) c GFCP BREAKER (30mA) d SHUNT TRIP BREAKER							12.20	12.24	11.94	<input checked="" type="checkbox"/> GROUND BUS <input type="checkbox"/> SPLIT BUS <input type="checkbox"/> FEED THRU LUGS <input type="checkbox"/> INTEGRAL SPD/TVSS							PHASE A: 101.7A PHASE B: 102.0A PHASE C: 99.5A		
e HANDLE PADLOCK f HANDLE CLAMP g RED CB HANDLE																			

NOTES: (APPLICABLE TO PANELBOARD LR1D ONLY)

1. -

BUS AMPACITY: 100A MAIN TYPE: 100A MCB SERVICE: 3 PHASE, 4 WIRE, 208Y/120 VOLTS MIN. RATING: 22K AIC RMS SYMMETRICAL AMPS										MOUNTING: SURFACE SECTION: 1 OF 1 ENCLOSURE: NEMA 1 LOCATION: ELECTRICAL ROOM M2X									
PANELBOARD LR2A																			
OCT	POLE	LOAD DESCRIPTION	NOTE	OCT BREAKER			KVA PER PHASE						OCT BREAKER			NOTE	LOAD DESCRIPTION	OCT	POLE
				P	TA	AUX	PHASE A		PHASE B		PHASE C	P	TA	AUX					
1	1	RECEPTACLES, ROOM M2X	-	1	20	-	0.60	1.16					1	20	-	-	FAN F-C6, ROOM 25	2	2
3	3	360-AH1 RECEPTACLE	-	1	20	-			0.20	1.16			1	20	-	-	FAN F-C6, ROOM 25	4	4
5	5	360-AH2 RECEPTACLE	-	1	20	-					0.20	0.40	1	20	-	-	CIRC. FAN CTRL PANEL	6	6
7	7	360-AH6, 360-EF6 RECEPTACLE	-	1	20	-	0.40	0.40					1	20	-	-	CIRC. FAN CTRL PANEL	8	8
9	9	REC. MECH M3X	-	1	20	-			0.20	0.60			1	20	-	-	ELEC ROOM FAN	10	10
11	11	LIGHTING RELAY PANEL	-	1	20	-					0.40	0.40	1	20	-	-	LIGHTING CONTROL PANEL	12	12
13	13	SPARE	-	1	20	-	-	-					1	20	-	-	SPARE	14	14
15	15	SPARE	-	1	20	-	-	-					1	20	-	-	SPARE	16	16
17	17	SPARE	-	1	20	-	-	-					1	20	-	-	SPARE	18	18
19	19	SPARE	-	1	20	-	-	-					1	20	-	-	SPARE	20	20
21	21	SPARE	-	1	20	-	-	-					1	20	-	-	SPARE	22	22
23	23	SPARE	-	1	20	-	-	-					1	20	-	-	SPARE	24	24
25	25	SPARE	-	1	20	-	-	-					1	20	-	-	SPARE	26	26
27	27	SPARE	-	1	20	-	-	-					1	20	-	-	SPARE	28	28
29	29	SPARE	-	1	20	-	-	-					1	20	-	-	SPARE	30	30
31	31	SPARE	-	1	20	-	-	-					1	20	-	-	SPARE	32	32
33	33	SPARE	-	1	20	-	-	-					1	20	-	-	SPARE	34	34
35	35	SPARE	-	1	20	-	-	-					1	20	-	-	SPARE	36	36
37	37	SPACE WITH PROVISIONS	-	1	-	-	-	-					1	-	-	-	SPACE WITH PROVISIONS	38	38
39	39	SPACE WITH PROVISIONS	-	1	-	-	-	-					1	-	-	-	SPACE WITH PROVISIONS	40	40
41	41	SPACE WITH PROVISIONS	-	1	-	-	-	-					1	-	-	-	SPACE WITH PROVISIONS	42	42
AUXILIARIES:							1.00	1.56	0.40	1.76	0.60	0.80	CONNECTED LOAD: 6.12KVA DEMAND LOAD: 6.12KVA DEMAND AMPS: 17.00A						
a AFCI BREAKER b GFCI BREAKER (5mA) c GFCP BREAKER (30mA) d SHUNT TRIP BREAKER							2.56	2.16	1.40	<input checked="" type="checkbox"/> GROUND BUS <input type="checkbox"/> SPLIT BUS <input type="checkbox"/> FEED THRU LUGS <input type="checkbox"/> SUB FEED LUGS <input type="checkbox"/> ISOLATED GROUND BUS <input type="checkbox"/> INTEGRAL SPD/TVSS									
e HANDLE PADLOCK f HANDLE CLAMP g RED CB HANDLE							PHASE A: 21.33A PHASE B: 18.00A PHASE C: 11.67A												

NOTES: (APPLICABLE TO PANELBOARD LR2A ONLY)

1. -

COMBINATION MOTOR STARTER DISCONNECT SCHEDULE																
DESIGNATION	VOLTS	POLES	NEMA ENCL	DISCONNECT			MOTOR STARTER					CONTROLS				
				CIRCUIT BREAKER	DISCONNECT SWITCH	DUAL ELEMENT FUSE	TYPE	NEMA SIZE	COIL VOLTS	AUXILIARY CONTACTS	OVERLOAD HEATERS	TRANSFORMER	PUSH BUTTON	PILOT LIGHT	SELECTOR SWITCH	NOTES
CMS-DOCK LIFT	208V	3	3R	-	30A	30A	-	1	-	-	NOTE 1	NOTE 2	NOTE 3	NOTE 4	NOTE 5	NOTE 6

NOTES: (APPLICABLE TO COMBINATION MOTOR STARTER DISCONNECT SCHEDULE ONLY)

- ELECTRICAL CONTRACTOR SHALL SIZE OVERLOAD HEATERS IN FIELD PER ACTUAL MOTOR NAMEPLATE DATA.
- UNIT SHALL BE EQUIPPED WITH CONTROL TRANSFORMER WITH 480V PRIMARY AND 120V FUSED SECONDARY.
- UNIT SHALL BE EQUIPPED WITH RED "RUN" AND GREEN "STOP" PUSHBUTTONS.
- UNIT SHALL BE EQUIPPED WITH RED "RUN" AND GREEN "OFF" PUSH TO TEST TYPE PILOT LIGHTS.
- UNIT SHALL BE EQUIPPED WITH HOA SELECTOR SWITCH.

BUS AMPACITY: 150A MAIN TYPE: 150A MCB SERVICE: 3 PHASE, 4 WIRE, 208Y/120 VOLTS MIN. RATING: 10K AIC RMS SYMMETRICAL AMPS										MOUNTING: SURFACE SECTION: 1 OF 1 ENCLOSURE: NEMA 1 LOCATION: ELECTRICAL ROOM 152										
PANELBOARD LR1E																				
OCT	Pole	LOAD DESCRIPTION	NOTE	OCT BREAKER			KVA PER PHASE						OCT BREAKER			NOTE	LOAD DESCRIPTION	OCT	Pole	
				P	TA	AUX	PHASE A		PHASE B		PHASE C		P	TA	AUX					
1	1	RECEPTACLES - RMS 155,157	-	1	20	-	0.80	2.29						2	30	-	-	DRYER - RM 153	2	2
3	3	RECEPTACLES - RM 156	-	1	20	-			1.20	2.29						-	-	{ }	4	4
5	5	RECEPTACLES - RMS 152,153	-	1	20	-						1.00	1.80	1	20	-	-	WASHING MACHINE - RM 153	6	6
7	7	RECEPTACLES - RMS 151,159	-	1	20	-	1.20	1.00						1	20	-	-	RECEPTACLES - RMS 12,24	8	8
9	9	RECEPTACLES - RM 20	-	1	20	-			1.20	0.50				1	20	-	-	RECEPTACLES - RMS 21,25	10	10
11	11	OVERHEAD COIL DOOR, ROOM 36A	-	1	20	-					1.20	0.80	1	20	-	-	RECEPTACLES - RMS 36A,36B	12	12	
13	13	OVERHEAD COIL DOOR, ROOM 36A	-	1	20	-	1.20	1.20						1	20	-	-	OVERHEAD COIL DOOR, ROOM 151	14	14
15	15	OVERHEAD COIL DOOR, ROOM 36B	-	1	20	-			1.20	0.50				1	20	-	-	RECEPTACLES - RM 25	16	16
17	17	OVERHEAD COIL DOOR, ROOM 36B	-	1	20	-					1.20	0.80	1	20	-	-	RECEPTACLES - RM 20	18	18	
19	19	FLOOR SCALE	-	1	20	-	1.00	0.72						1	20	-	-	POWER DOOR	20	20
21	21	UH-1	-	1	20	-			1.20	-				1	20	-	-	SPARE	22	22
23	23	SPARE	-	1	20	-					-	-	-	1	20	-	-	SPARE	24	24
25	25	SPARE	-	1	20	-					-	-	-	1	20	-	-	SPARE	26	26
27	27	SPARE	-	1	20	-			-	-	-	-	-	1	20	-	-	SPARE	28	28
29	29	SPARE	-	1	20	-					-	-	-	1	20	-	-	SPARE	30	30
31	31	SPARE	-	1	20	-			-	-	-	-	-	1	20	-	-	SPARE	32	32
33	33	SPARE	-	1	20	-			-	-	-	-	-	1	20	-	-	SPARE	34	34
35	35	SPARE	-	1	20	-					-	-	-	1	20	-	-	SPARE	36	36
37	37	SPACE WITH PROVISIONS	-	1	-	-	-	-	-	-	-	-	-	1	-	-	-	SPACE WITH PROVISIONS	38	38
39	39	SPACE WITH PROVISIONS	-	1	-	-	-	-	-	-	-	-	-	1	-	-	-	SPACE WITH PROVISIONS	40	40
41	41	SPACE WITH PROVISIONS	-	1	-	-	-	-	-	-	-	-	-	1	-	-	-	SPACE WITH PROVISIONS	42	42
AUXILIARIES:							4.20	5.21	4.80	4.49	3.40	3.40	CONNECTED LOAD: 25.5KVA DEMAND LOAD: 19.3KVA DEMAND AMPS: 53.6A							<input checked="" type="checkbox"/> GROUND BUS <input type="checkbox"/> SPILT BUS <input type="checkbox"/> FEED THRU LUGS <input type="checkbox"/> 200% NEUTRAL BUS & LUGS <input type="checkbox"/> SUB FEED LUGS <input type="checkbox"/> ISOLATED GROUND BUS <input type="checkbox"/> INTEGRAL SPD/TVSS
a AFCI BREAKER b GFCI BREAKER (5mA) c GFFP BREAKER (30mA) d SHUNT TRIP BREAKER							e HANDLE PADLOCK f HANDLE CLAMP g RED CB HANDLE							PHASE A: 78.24A PHASE B: 77.42A PHASE C: 56.67A						